

ROOF REPLACEMENTS: DAVID MORGAN COMMONS, ANCHORAGE HOMES, & OAK TREE VILLAS GRANITE CITY HOUSING AUTHORITY


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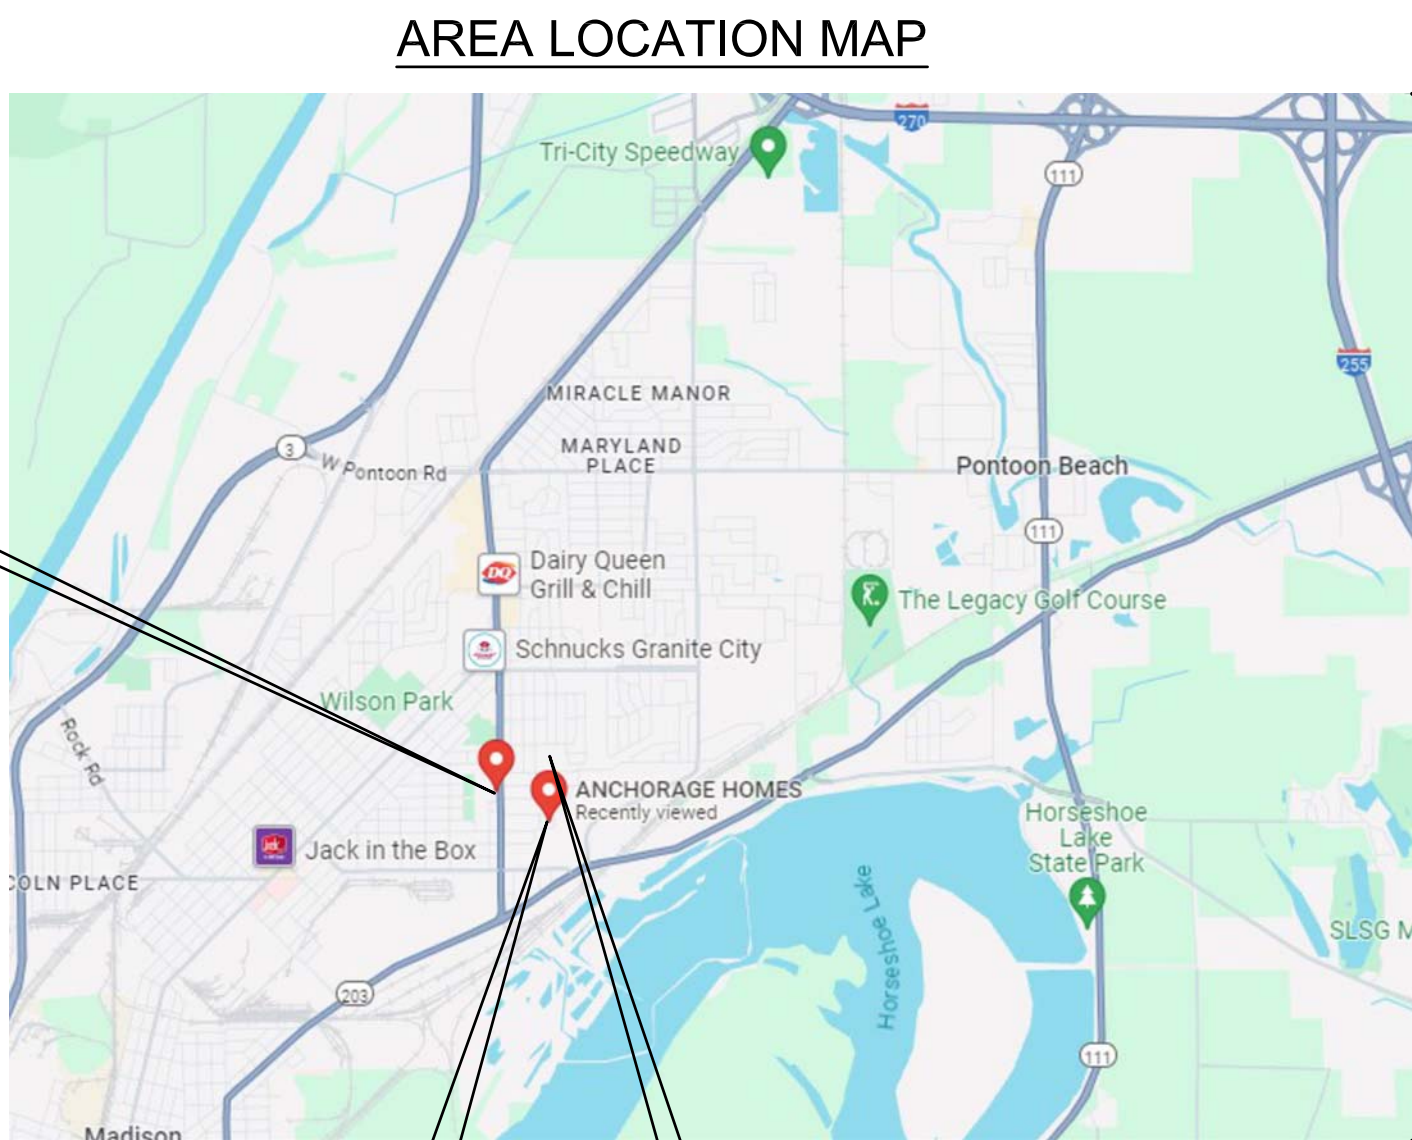
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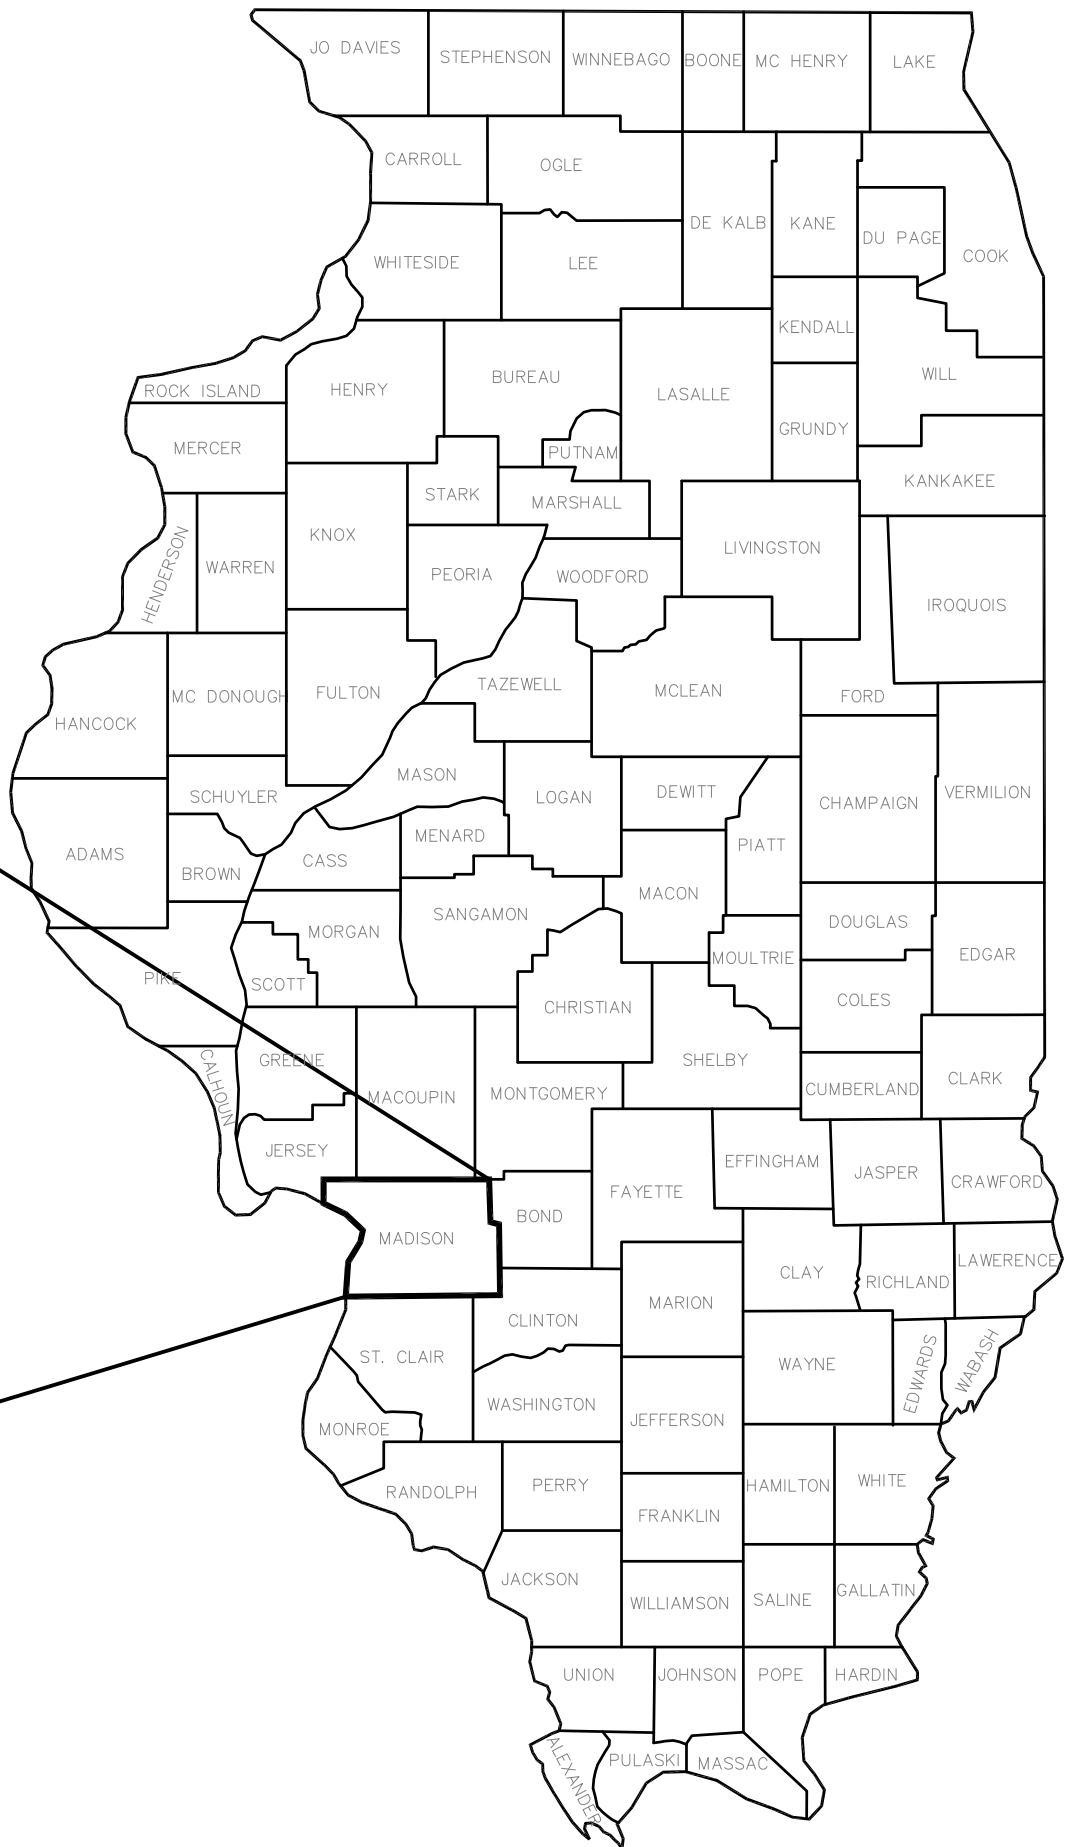
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DAVID MORGAN COMMONS



AREA LOCATION MAP



CODE REFERENCE:

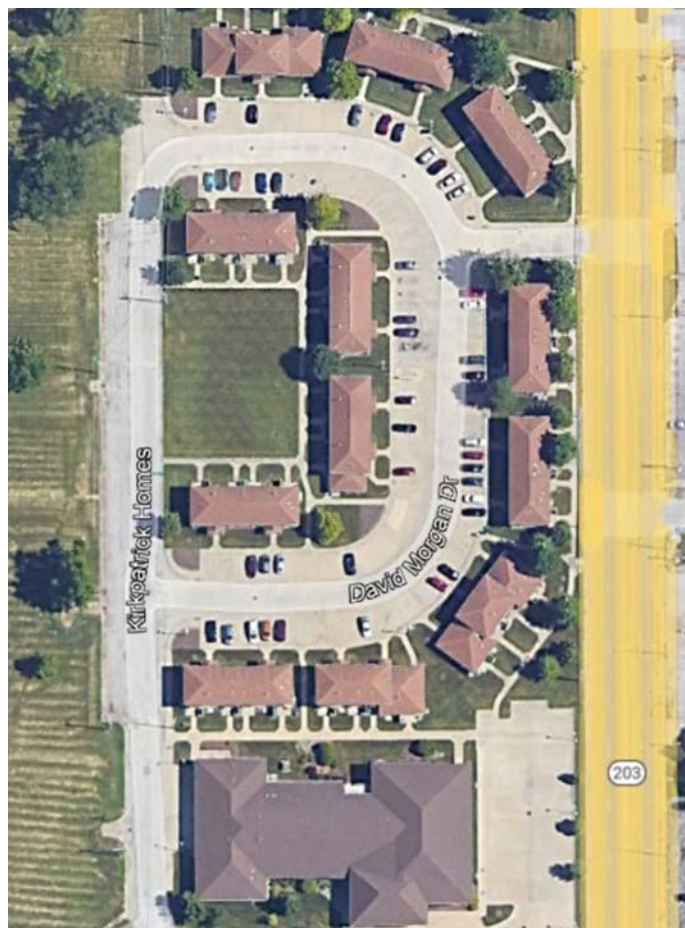INTERNATIONAL BUILDING CODE, LATEST EDITION
INTERNATIONAL MECHANICAL CODE, LATEST EDITION
ILLINOIS PLUMBING CODE, LATEST EDITION
ILLINOIS ACCESSIBILITY CODE, LATEST EDITION
NATIONAL ELECTRIC CODE, LATEST EDITION




Granite City
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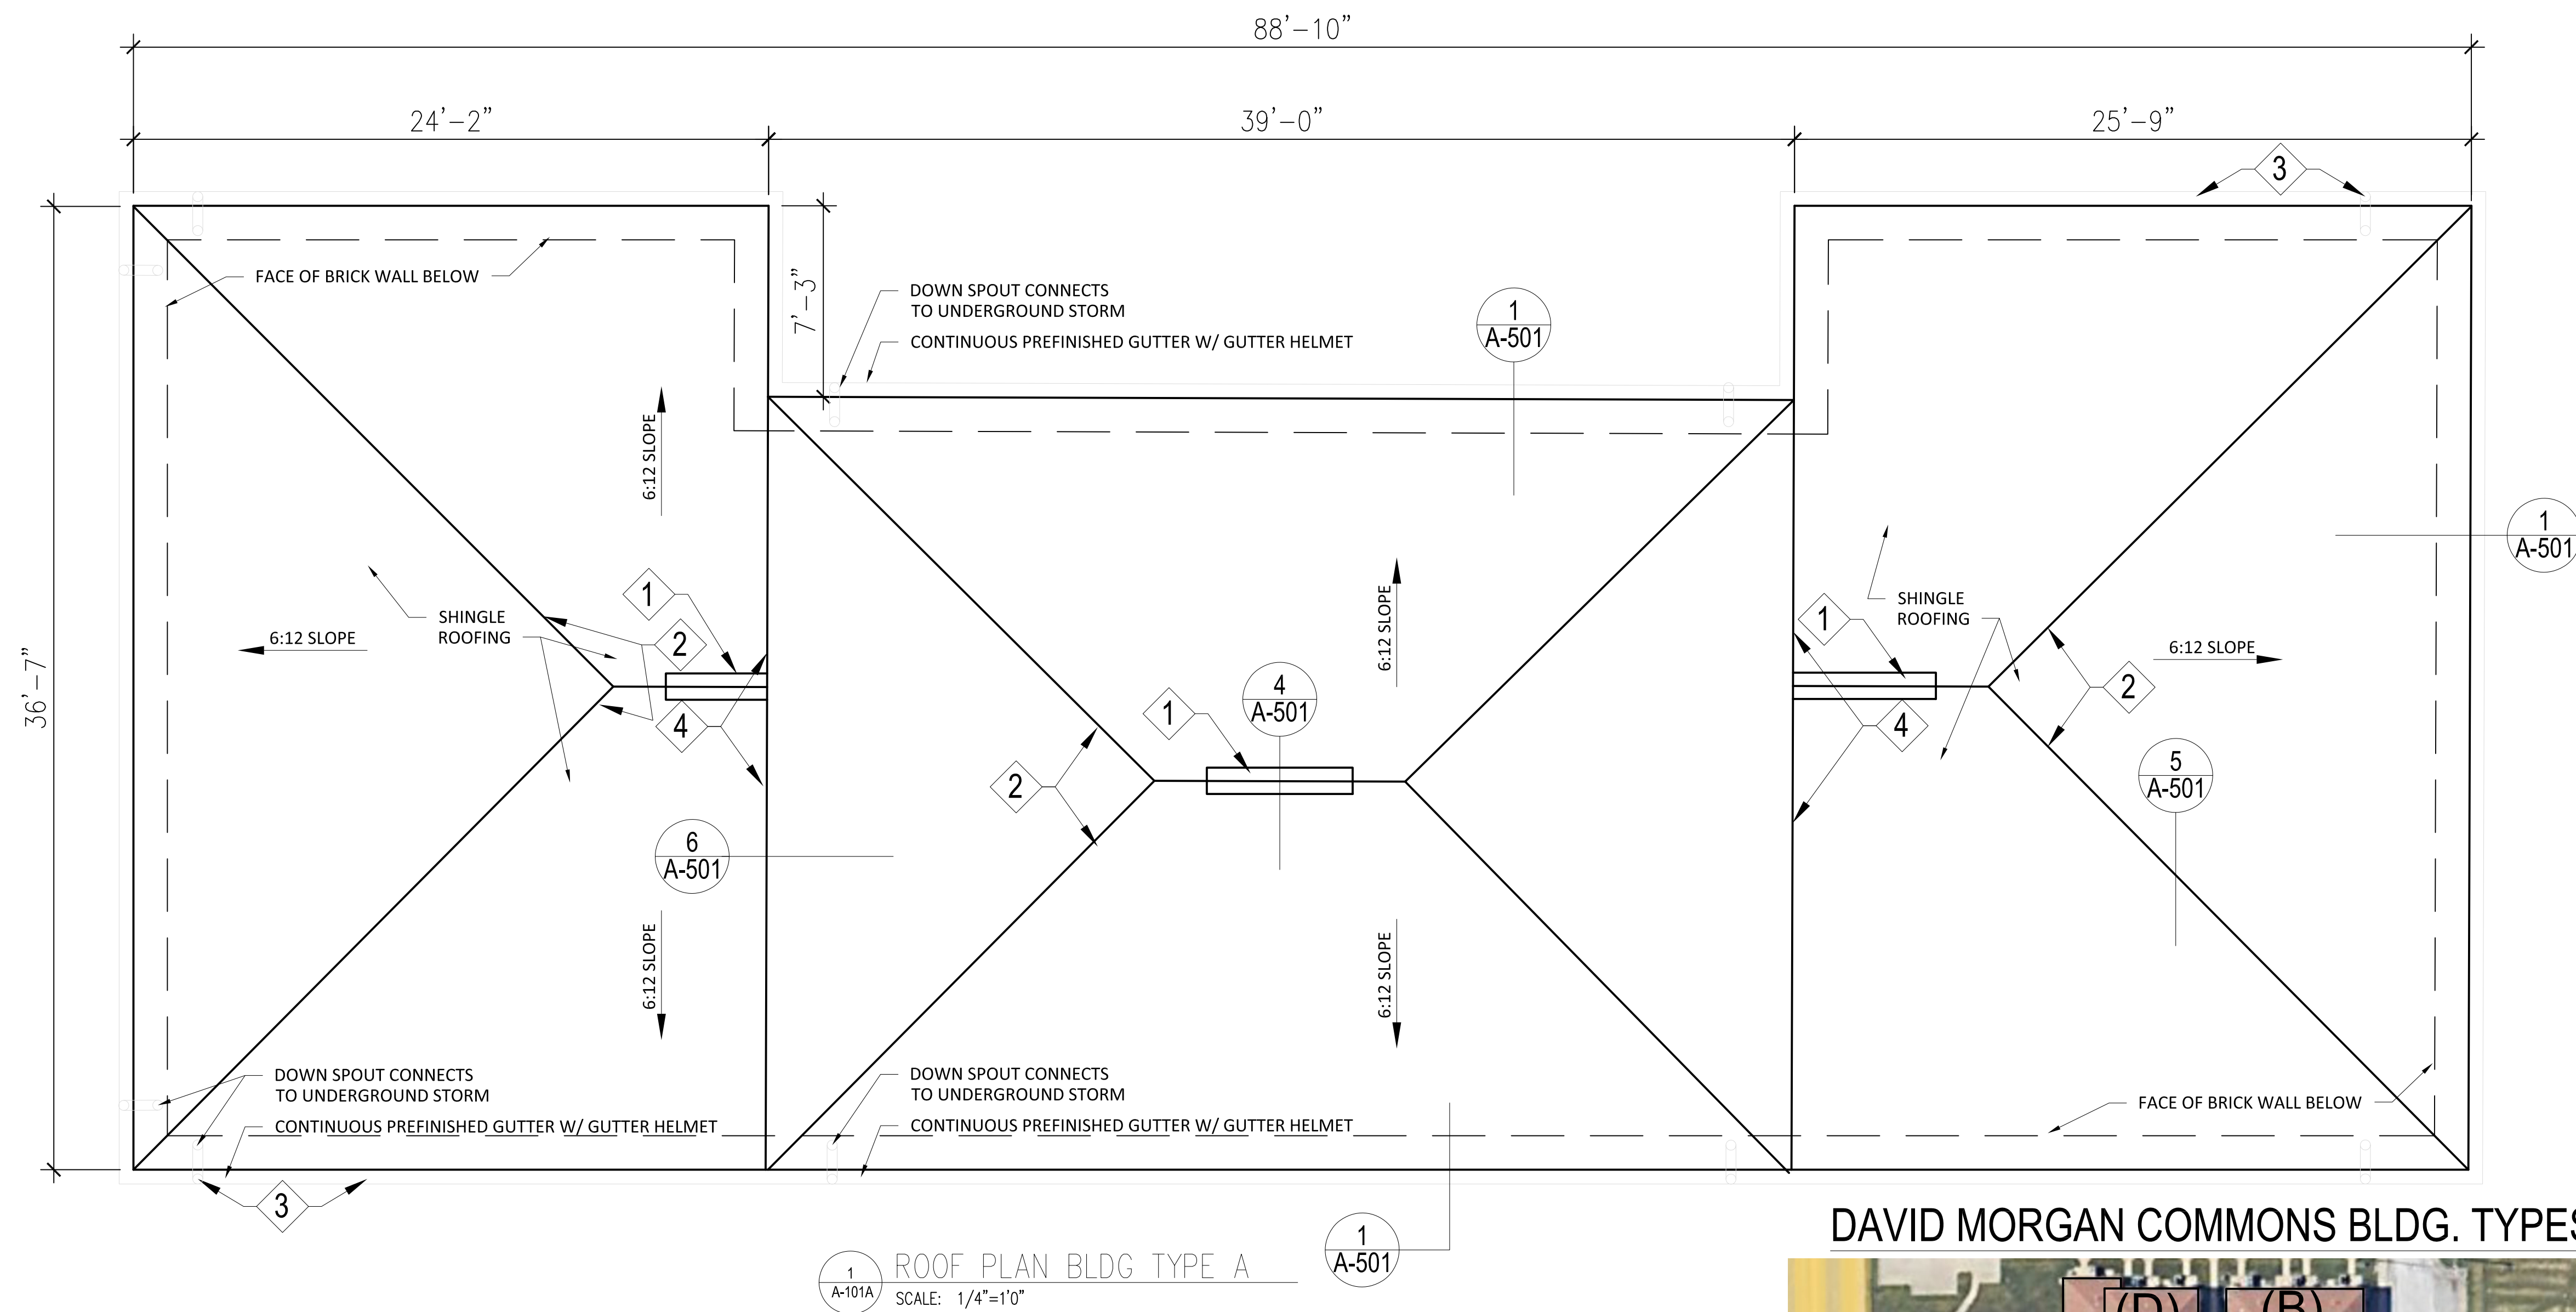
ANCHORAGE HOMES



OAK TREE VILLAS

DATE: 03/11/2024

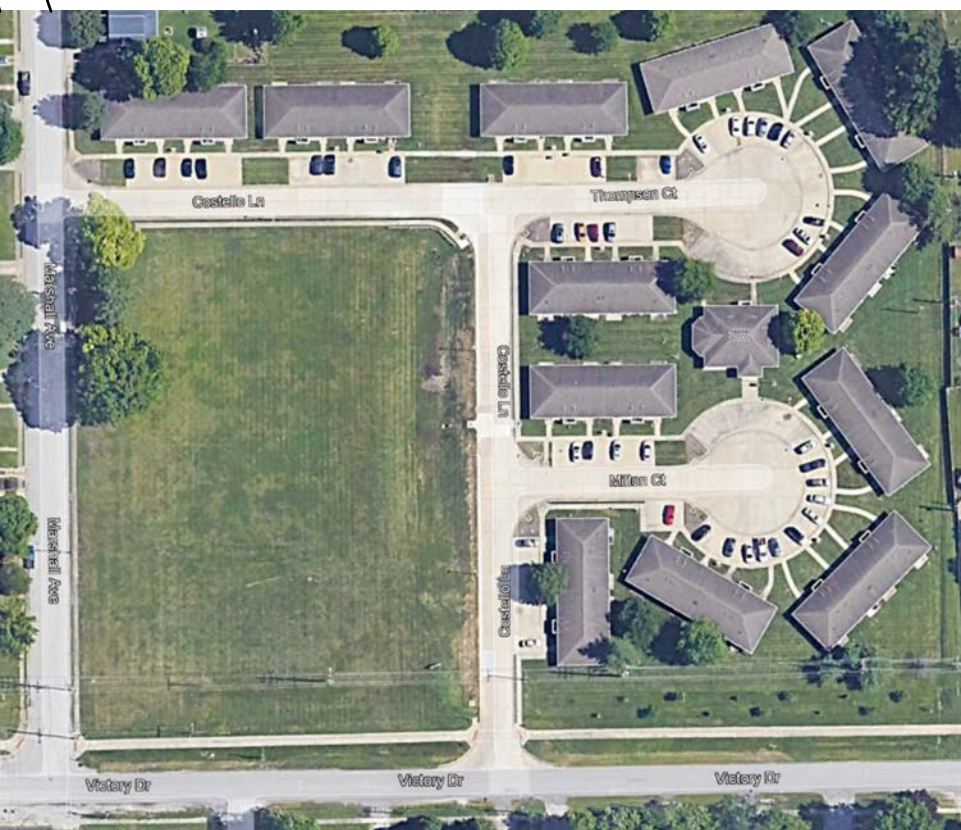ABBREVIATIONS								GENERAL NOTES: (APPLY TO ALL WORK)	
ABV AFF ACC AP AC ACT ADH ADJ ADJT ALT AL ANC AB ARCH AD ASPH AUTO	ABOVE ABOVE FINISH FLOOR ACCESS ACCESS PANEL ACOUSTICAL ACOUSTICAL CEILING TILE ADHEASIVE ADJACENT ADJUSTABLE ALTERNATE, ALTERNATIVE ALUMINUM ANCHOR, ANCHORAGE ANCHOR BOLT ARCHITECT (URAL) AREA DRAIN ASPHALT AUTOMATIC	EF ELEC EP EL ELEV ENC EQ EQP EST EXH EXG EJ EXP EXT EWC	EACH FACE ELECTRIC (AL) ELECTRICAL PANELBOARD ELEVATION ELEVATOR ENCLOSE (URE) EQUAL EQUIPMENT ESTIMATE EXHAUST EXISTING EXPANSION JOINT EXPOSED EXTERIOR ELECTRIC WATER COOLER	JT JOINT JF JOIST KPL KICKPLATE LBL LABEL LAD LADDER LAM LAMINATE (D) LAV LAVATORY LH LEFT HAND L LENGTH LT LIGHT LW LIGHTWEIGHT LF LINEAL FEET LTL LINTEL LL LIVE LOAD LVR LOUVER LPT LOW POINT	RAD RL RE RFL REINF REM RES RET RA RVS REV RH RFG RM RO RB	RADIUS RAIL (ING) REFERENCE REFLECT (ED), (IVE), (OR) REINFORCE (D), (ING) REMOVE RESILIENT RETURN RETURN AIR REVERSE (SIDE) REVISION (S), REVISED RIGHT HAND ROOFING ROOM ROUGH OPENING RUBBER BASE			
BRG BPL BM BEL BTWN BVL BLK BLKG BD BS BW BOT BLDG BL	BEARING BEARING PLATE BENCH MARK, BEAM BELOW BETWEEN BEVELED BLOCK BLOCKING BOARD BOTH SIDES BOTH WAYS BOTTOM BUILDING BRICK LEDGE	FOC FOF FOM FOS FAS FBD FGL FIN FFE FFL FA FE FEC FPL FP FRT FLG FLX FLR FD FPL FLUR FJT FTG FND FR FRA FS FBO FUR FUT	FACE OF CONCRETE FACE OF FINISH FACE OF MASONRY FACE OF STUDS FASTEN, FASTENER FIBERBOARD FIBERGLASS FINISH (ED) FINISHED FLOOR ELEVATION FINISHED FLOOR LINE FIRE ALARM FIRE EXTINGUISHER FIRE EXTINGUISHER CABINET FIREPLACE FIREPROOF FIRE-RETARDANT FLASHING FLEXIBLE FLOOR (ING) FLOOR DRAIN FLOOR PLATE FLUORESCENT FLUSH JOINT FOOTING FOUNDATION FRAME (D), (ING) FRESH AIR FULL SIZE FURNISHED BY OTHERS FURRED (ING) FUTURE	MI MFR MAS MO MAX MECH MED MBR MMB MTL MWK MIN MISC MLD MT MOV MULL	SCH S SEC SHTG SHT SH SIM SL SC SPL SPEC SQ SF SY S&V SST STD STA STL STO STRUCT SYM SYS	SCHEDULE SEALER SECTION SHEATHING SHEET SHELF, SHELVING SIMILAR SLEEVE SOLID CORE SPECIAL SPECIFICATIONS SQUARE SQUARE FOOT SQUARE YARD STAINED AND VARNISHED STAINLESS STEEL STANDARD STATION STEEL STORAGE STRUCTURAL SYMMETRY (ICAL) SYSTEM			
CAB CPT CSMT CK CLG CEM CER CT CHAM CIR CLR CLS COL COMB COMP CONC CMU CONST CONT CONTR CLL CJ CPR CG CTR CFL CS CF CY	CABINET CARPET (ED) CASEMENT CAULKING CEILING CEMENT CERAMIC CERAMIC TILE CHAMFER CIRCLE CLEAR (ANCE) CLOSURE COLUMN COMBINATION COMPRESS (ED), (ION), (IBLE) CONCRETE CONCRETE MASONRY UNIT CONSTRUCTION CONTINUOUS CONTRACT (OR) CONTRACT LIMIT LINE CONTROL JOINT COPPER CORNER GUARD CENTER COUNTERFLASHING COUNTERSINK CUBIC FOOT CUBIC YARD	GA GALV GC GLF GB GR GVL GRT GYP BD HDW HWD HJT HDR HTG HD HT HC HM HORIZ HB HWH HSS	GAGE, GUAGE GALVANIZED GENERAL CONTRACT (OR) GLASS FIBER GRAB BAR GRADE, GRADING GRAVEL GROUT GYPSUM BOARD HARDWARE HARDWOOD HEAD JOINT HEADER HEATING HEAVY DUTY HEIGHT HOLLOW CORE HOLLOW METAL HORIZONTAL HOSE BIB HOT WATER HEATER STRUCTURAL TUBE	OC OPG OPP OD OA OH P PNL PAR PK PTN PERF PERI PLAS PLAM PL PWD PT PORC. PVC PCF PLF PSF PSI PFB PFN PRF PL	TEL TV THK THR TOL T&G T.STL TSL TFTG TYP UC UNF VJ VR VAR VNR VERT VWC	TELEPHONE TELEVISION THICK (NESS) THRESHOLD TOLERANCE TONGUE AND GROOVE TOP OF STEEL TOP OF SLAB TOP OF FOOTING TYPICAL UNDERCUT UNFINISHED V-JOINT (ED) VAPOR RETARDER VARNISH VENEER VERTICAL VINYL WALL COVERING			
DPR DL DEM DMT DEP DTL DIAG DIAM DIM DIV DR DBL DH DWL DS DT DWR DWG	DAMPER DEAD LOAD DEMOLISH, DEMOLITION DEMOUNTABLE DEPRESSED DETAIL DIAGONAL DIAMETER DIMENSION DIVISION DOOR DOUBLE DOUBLE HUNG DOWEL(S) DOWNSPOUT DRAIN TILE DRAWER DRAWING	IN INCL ID IF INS INT	INCH INCLUDING INSIDE DIAMETER INSIDE FACE INSULATE (D), (ION) INTERIOR		WSCT WC WP WR WS WWF W w/ WDW W/O WD WB WPT	WAINSCOT WATER CLOSET WATERPROOFING WATER REPELLENT WATERSTOP WELDED WIRE FABRIC WIDTH, WIDE WITH WINDOW WITHOUT WOOD WOOD BASE WORKING POINT			
								1. THE CONTRACTOR SHALL COORDINATE ALL WORK WITH THE PHA. LOCATE CONTRACTOR PARKING AND CONSTRUCTION STAGING AS INDICATED BY THE PHA AND NOTIFY RESIDENTS A MINIMUM OF 48 HOURS PRIOR TO CONDUCTING WORK AT OCCUPIED BUILDINGS.	
								2. PERMITS AND LICENSES OF A TEMPORARY NATURE NECESSARY FOR THE PROCESSION OF WORK SHALL BE SECURED AND PAID FOR BY THE CONTRACTOR.	
								3. THE CONTRACTOR IS RESPONSIBLE FOR CONSTRUCTION LAYOUT. NEW WORK SHALL MATCH EXISTING ADJOINING CONSTRUCTION FOR A SMOOTH TRANSITION UNLESS OTHERWISE NOTED.	
								4. CONTRACTOR SHALL TAKE ALL PRECAUTIONS NECESSARY TO AVOID DAMAGE TO EXISTING CONSTRUCTION AND SITE IMPROVEMENTS INCLUDING BUILDINGS, UTILITIES, LAWNS, LANDSCAPING, PARKING AREAS, CONCRETE SIDEWALKS, STOOPS, AND PATIOS TO REMAIN AND SHALL REPAIR DAMAGE CAUSED BY CONSTRUCTION / DEMOLITION AT NO ADDITIONAL COST TO THE OWNER. PROTECT EXISTING EXISTING CONSTRUCTION AS NECESSARY TO PREVENT DAMAGE.	
								5. DIMENSIONS AND QUANTITIES NOTED ON DRAWINGS ARE APPROXIMATE AND ARE FOR GENERAL INFORMATION ONLY. THE CONTRACTOR SHALL VERIFY ALL EXISTING AND NEW DIMENSIONS WITH FIELD CONDITIONS PRIOR TO BIDDING, FABRICATION, AND CONSTRUCTION AND MAKE MINOR ADJUSTMENTS AS NECESSARY. NOTIFY THE ARCHITECT/ENGINEER OF ANY CONDITIONS THAT MAY AFFECT THE OUTCOME OF THE WORK.	
								6. MAINTAINING DRAINAGE - IT SHALL BE THE RESPONSIBILITY OF THE CONTRACTOR TO MAINTAIN DRAINAGE FLOWS AT ALL TIMES DURING THE PERFORMANCE OF THE WORK. DAMAGE RESULTING FROM IMPROPER MAINTENANCE OF DRAINAGE SHALL BE IMMEDIATELY REPAIRED BY THE CONTRACTOR AT NO ADDITIONAL COST TO THE PHA. COST OF MAINTAINING FLOWS IS INCIDENTAL TO THE CONTRACT.	
								7. THE CONTRACTOR IS RESPONSIBLE FOR THE PROTECTION AND SECURITY OF THE BUILDINGS, MATERIALS, EQUIPMENT AND SUPPLIES RELATED TO THIS CONTRACT. CONTRACTOR SHALL FURNISH, ERECT AND MAINTAIN TEMPORARY BARRIERS, ENCLOSURES, AND FENCING AS NECESSARY TO PREVENT UNAUTHORIZED ENTRY TO CONSTRUCTION AREAS.	
								8. CONTRACTOR SHALL REMOVE EXISTING CONSTRUCTION TO THE EXTENT SHOWN ON PLANS AND LEGALLY DISPOSE OF OFF-SITE. CONTRACTOR SHALL ALSO REMOVE AND DISPOSE OF ALL SURPLUS, UNSTABLE AND/OR UNSUITABLE MATERIALS RESULTING FROM CONSTRUCTION OF THIS PROJECT. THE CONTRACTOR SHALL TAKE NOTE OF EXISTING SITE CONDITIONS AND BE PREPARED TO MOVE OR DISPOSE OF OBJECTS OR MATERIALS WITHIN THE LIMITS OF THE PROJECT AS NECESSARY TO COMPLETE THE WORK. SUCH WORK SHALL NOT BE CAUSE FOR ADDITIONAL COMPENSATION FOR A CHANGE IN THE SCOPE.	
								SIGNATURE xx-xx-2024	
								DATE 11-30-2024	
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								BP3, ROOF REPLACEMENTS, MULTIPLE SITES:	
								DAVID MORGAN COMMONS ANCHORAGE HOMES OAK TREE VILLAS GRANITE CITY HOUSING AUTHORITY GRANITE CITY, ILLINOIS 62040	
								DATE: 03-11-2024	
								PROJECT NO: 280-0464	
								DESIGN: JLV DRAWN: JSM CHECK: JLV	
								LEGEND OF SYMBOLS, GENERAL NOTES & ABBREVIATIONS	
								G-102	



NOTE:
DIMENSIONS ARE APPROXIMATE.
CONFIRM IN FIELD

GENERAL NOTES:

1. CONTRACTOR SHALL FIELD VERIFY ALL DIMENSIONS AND CONDITIONS AND MAKE MINOR ADJUSTMENTS AS NECESSARY. NOTIFY ARCHITECT OF ANY DISCREPANCIES WHICH MAY AFFECT THE OUTCOME OF THE WORK.
2. ALL EXISTING FINISHES DISTURBED DURING CONSTRUCTION SHALL BE RESTORED TO A CONDITION AT LEAST EQUAL IN MATERIAL AND APPEARANCE TO THAT WHICH EXISTED BEFORE CONSTRUCTION BEGAN.
3. THE CONTRACTOR SHALL BE RESPONSIBLE FOR PAYING ALL PERMIT FEES, PAY ITEM AGREEMENTS, TAP FEES, ETC.
4. WHETHER SHOWN OR NOT, CONTRACTOR SHALL PROVIDE ALL COMPONENTS REQUIRED TO A COMPLETE INSTALLATION. THIS APPLIES TO ALL TRADES AND DISCIPLINES.
5. UPON COMPLETION OF CONSTRUCTION ACTIVITIES, CONTRACTOR SHALL CLEAN ALL WORK AREAS SO THAT THEY ARE FREE OF ALL CONSTRUCTION DIRT AND DEBRIS.
6. PROTECT EXISTING UTILITIES DURING CONSTRUCTION.
7. EXISTING SITE AND BUILDING WILL BE OCCUPIED THROUGHOUT CONSTRUCTION. PROVIDE ACCESS TO ALL USERS AND EMERGENCY VEHICLES/PERSONEL AT ALL TIMES. CONTRACTOR TO USE SPECIAL CAUTION IN THE COURSE OF THE WORK, PROTECTION OF THE RESIDENTS AND GUESTS FROM THE WORK, AND CONTINUAL CLEAN-UP WITH NO DEBRIS OR HAZARDS EXPOSED AT THE COMPLETION OF A WORK DAY. THIS APPLIED TO ALL TRADES AND DISCIPLINES.
8. CONTRACTOR'S USE OF ANY SCAFFOLDING, LIFTS, SWING STAGES, ETC. SHALL MEET ALL FEDERAL, STATE, AND LOCAL SAFETY REGULATIONS.

GENERAL ROOFING NOTES:

9. REMOVE ALL EXISTING ASPHALT ROOF SHINGLES AND FELT UNDERLAYMENT TO THE EXISTING ROOF SHEATHING. EXISTING PERIMETER ICE AND WATER DAM MEMBRANE SHALL REMAIN IN PLACE WHERE EXISTING.
10. CONTRACTOR SHALL REMOVE AND PROPERLY DISPOSE OF ALL EXISTING PERIMETER SHEET METAL DRIP EDGE FLASHING, GUTTERS AND DOWNSPOUTS. INSTALL NEW PREFINISHED ALUMINUM DRIP EDGE, GUTTERS AND DOWNSPOUTS TO MATCH EXISTING. SEE TYPICAL DETAILS ON SHEET A-501.
11. INSTALL NEW ARCHITECTURAL SHINGLES OVER SYNTHETIC UNDERLAYMENT AND NEW ICE DAM AT ROOF PERIMETER AND VALLEYS. CONTRACTOR SHALL REMOVE ALL EXISTING AND INSTALL NEW ROOF PENETRATION FLASHINGS AND ALUMINUM VENT CAPS. FIELD VERIFY SIZE, QUANTITY, AND LOCATION. SEE TYPICAL ROOFING DETAILS ON SHEET A-501.
12. CONTRACTOR SHALL TAKE NOTE OF ALL EXISTING BUILDING MOUNTED EQUIPMENT, UTILITIES, WIRING, FIXTURES, DEVICES AND ACCESSORIES INCLUDING BUT NOT LIMITED TO ALL, PHONE AND CABLE WIRES, SATELLITE DISHES, AIR CONDITIONING DISCONNECTS, AND ASSOCIATED WIRING AND ACCESSORIES, ETC. AND REMOVE AND REINSTALL AS REQUIRED TO COMPLETE ALL WORK.

KEYED NOTES:

1. REMOVE EXISTING AND INSTALL NEW SHINGLE-OVER RIDGE VENT. SEE TYP. DETAIL ON SHT. A-501.
2. REMOVE EXISTING AND INSTALL NEW VALLEY/TRANSITION FLASHING. SEE TYP. DETAIL ON SHT. A-501.
3. REMOVE EXISTING AND INSTALL NEW PREFINISHED, SEAMLESS ALUMINUM GUTTER AND DOWNSPOUTS INCLUDING ALL ASSOCIATED ELBOW, BRACKETS, ANCHORS AND ACCESSORIES REQUIRED FOR INSTALLATION. SIZE AND PROFILE TO MATCH EXISTING. SEE TYPICAL DETAILS ON SHEET A-501.
4. WALL FLASHING PER TYP. DETAIL ON SHT. A-501.

DAVID MORGAN COMMONS BLDG. TYPES



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OAK TREE VILLAS
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GRANITE CITY, ILLINOIS 62040

MK.	DATE	DESCRIPTION

DATE: 03-11-2024
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DAVID MORGAN COMMONS
ROOFING PLANS

A-101a

SIGNATURE
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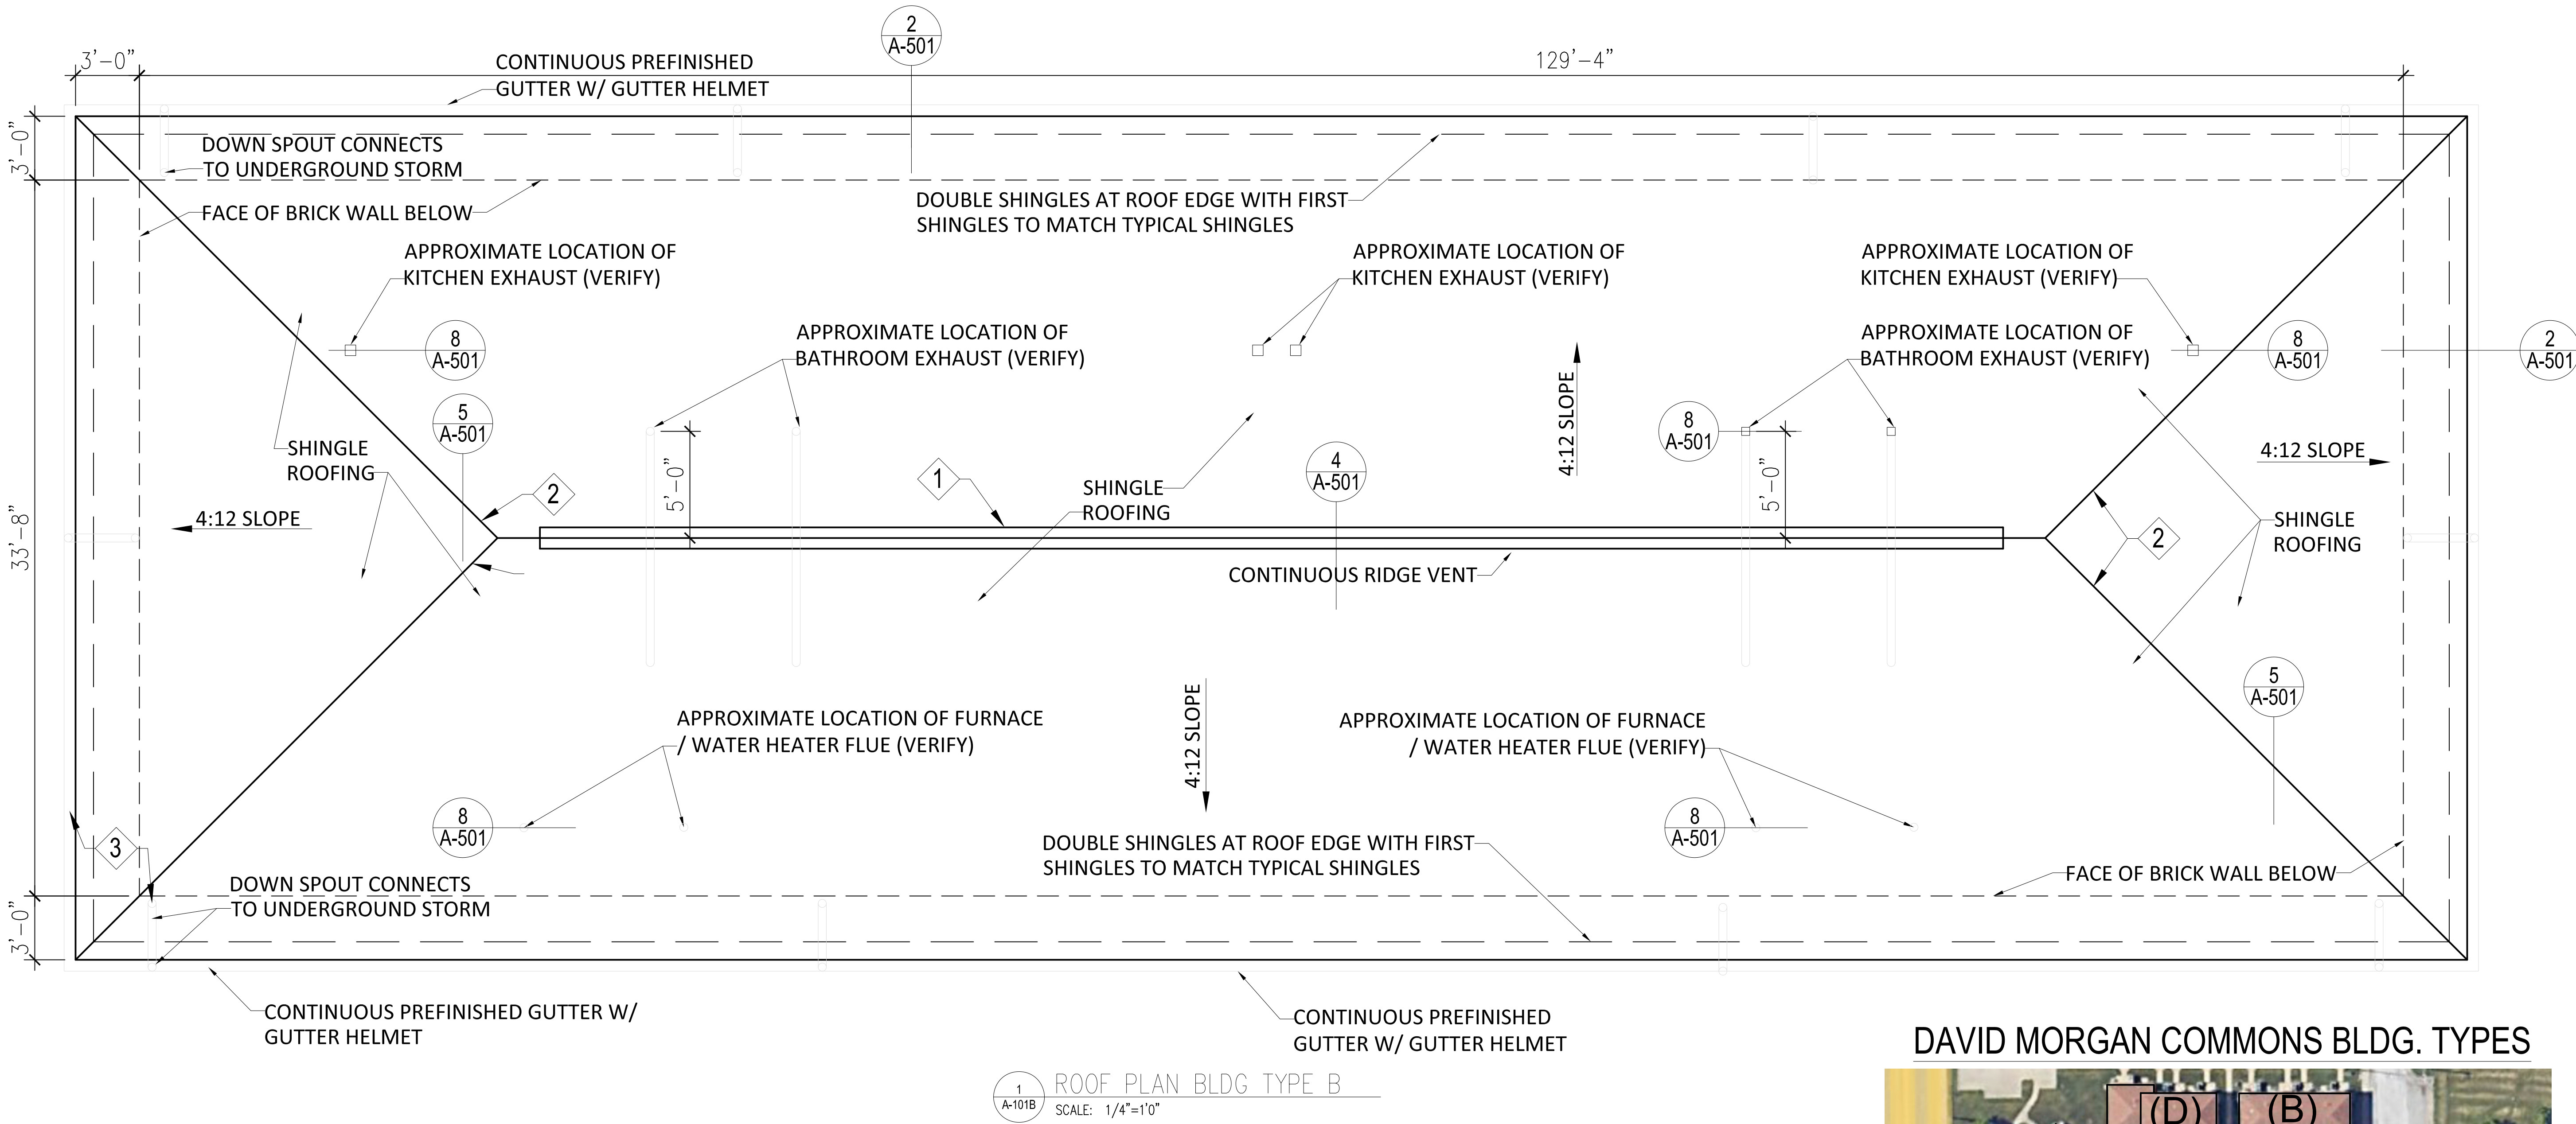
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DAVID MORGAN COMMONS

ROOFING PLANS

A-101b



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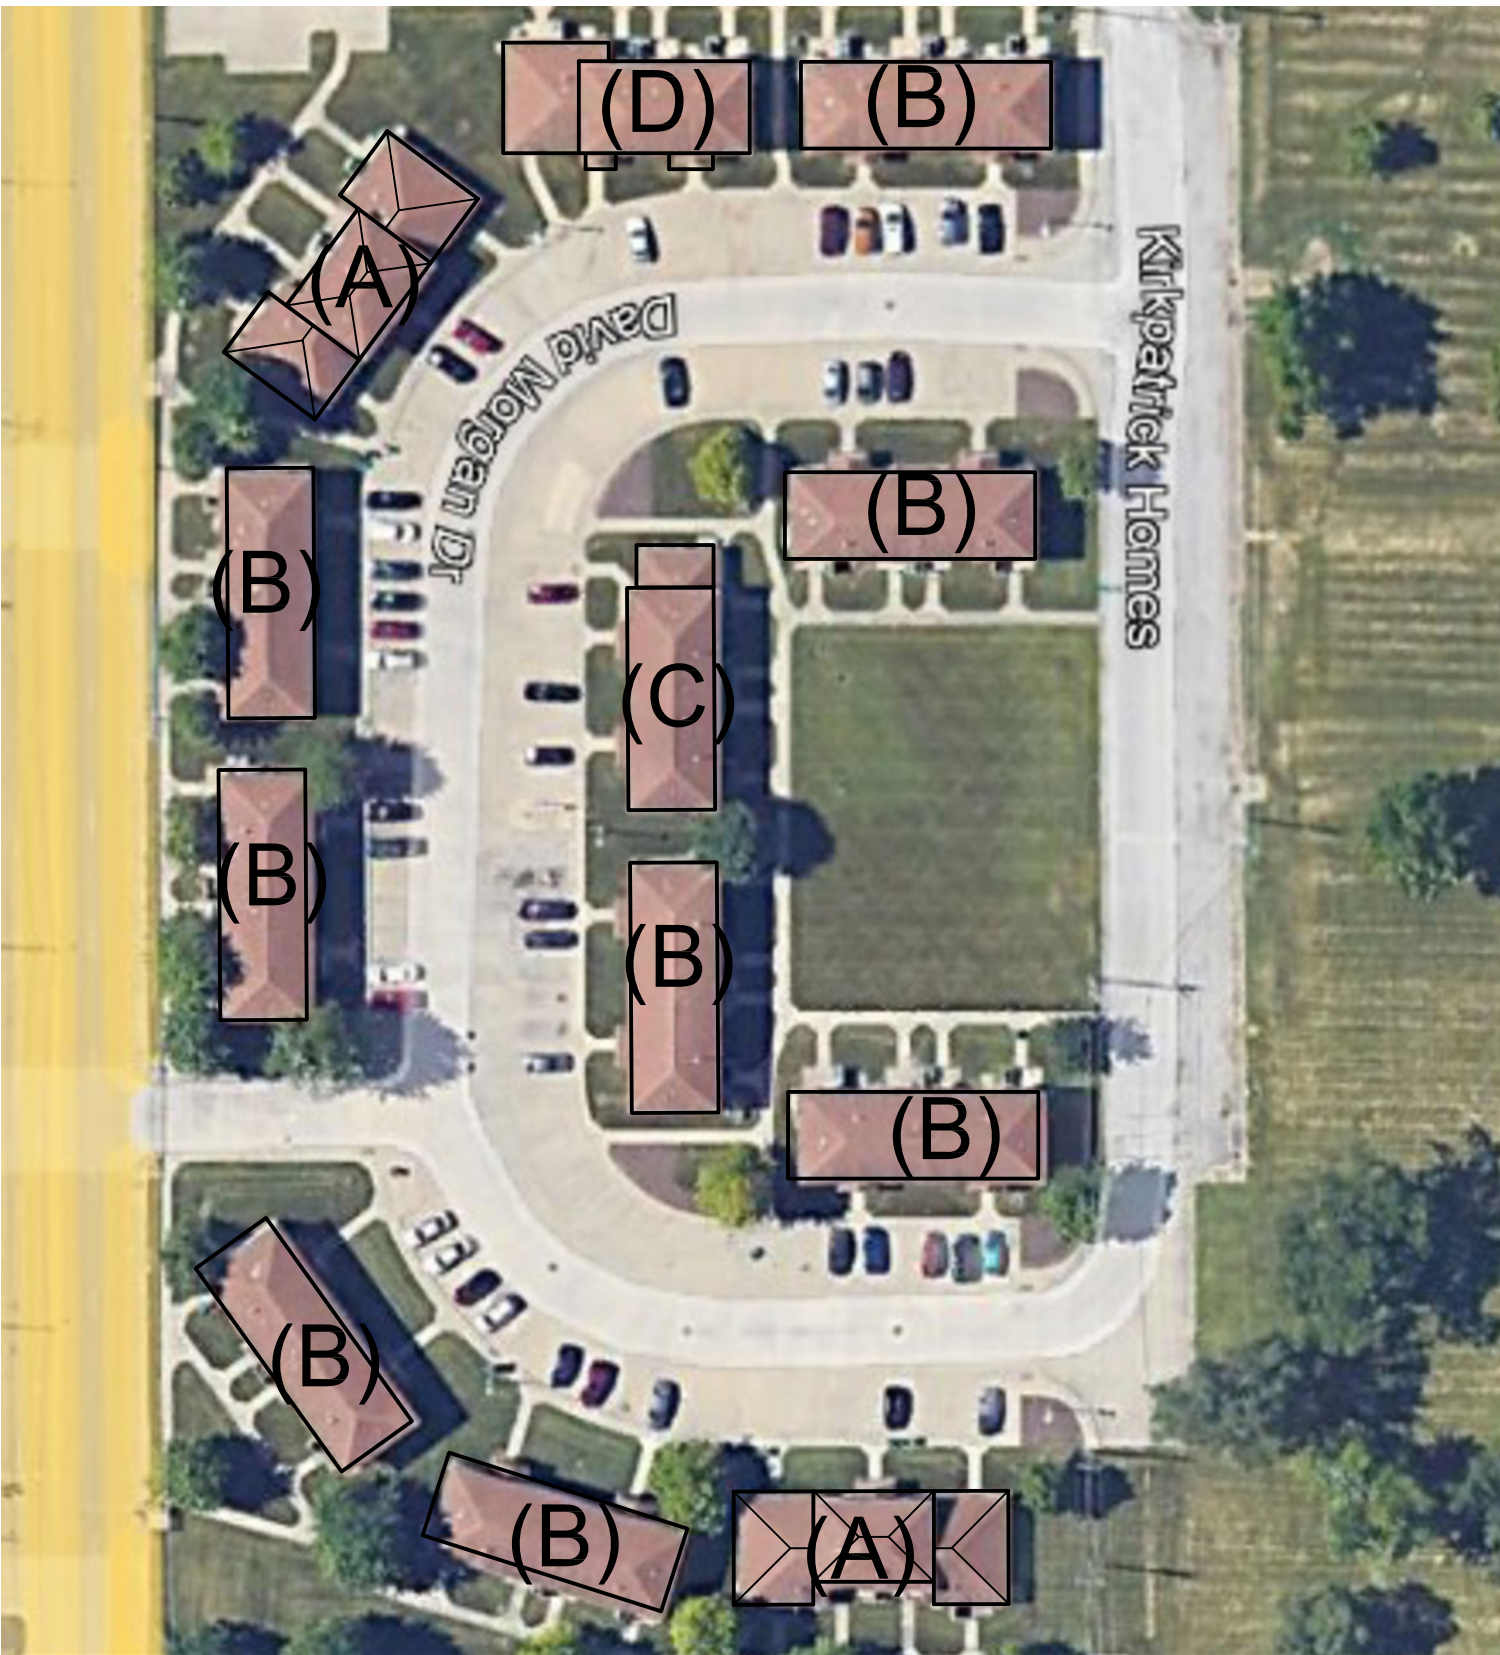
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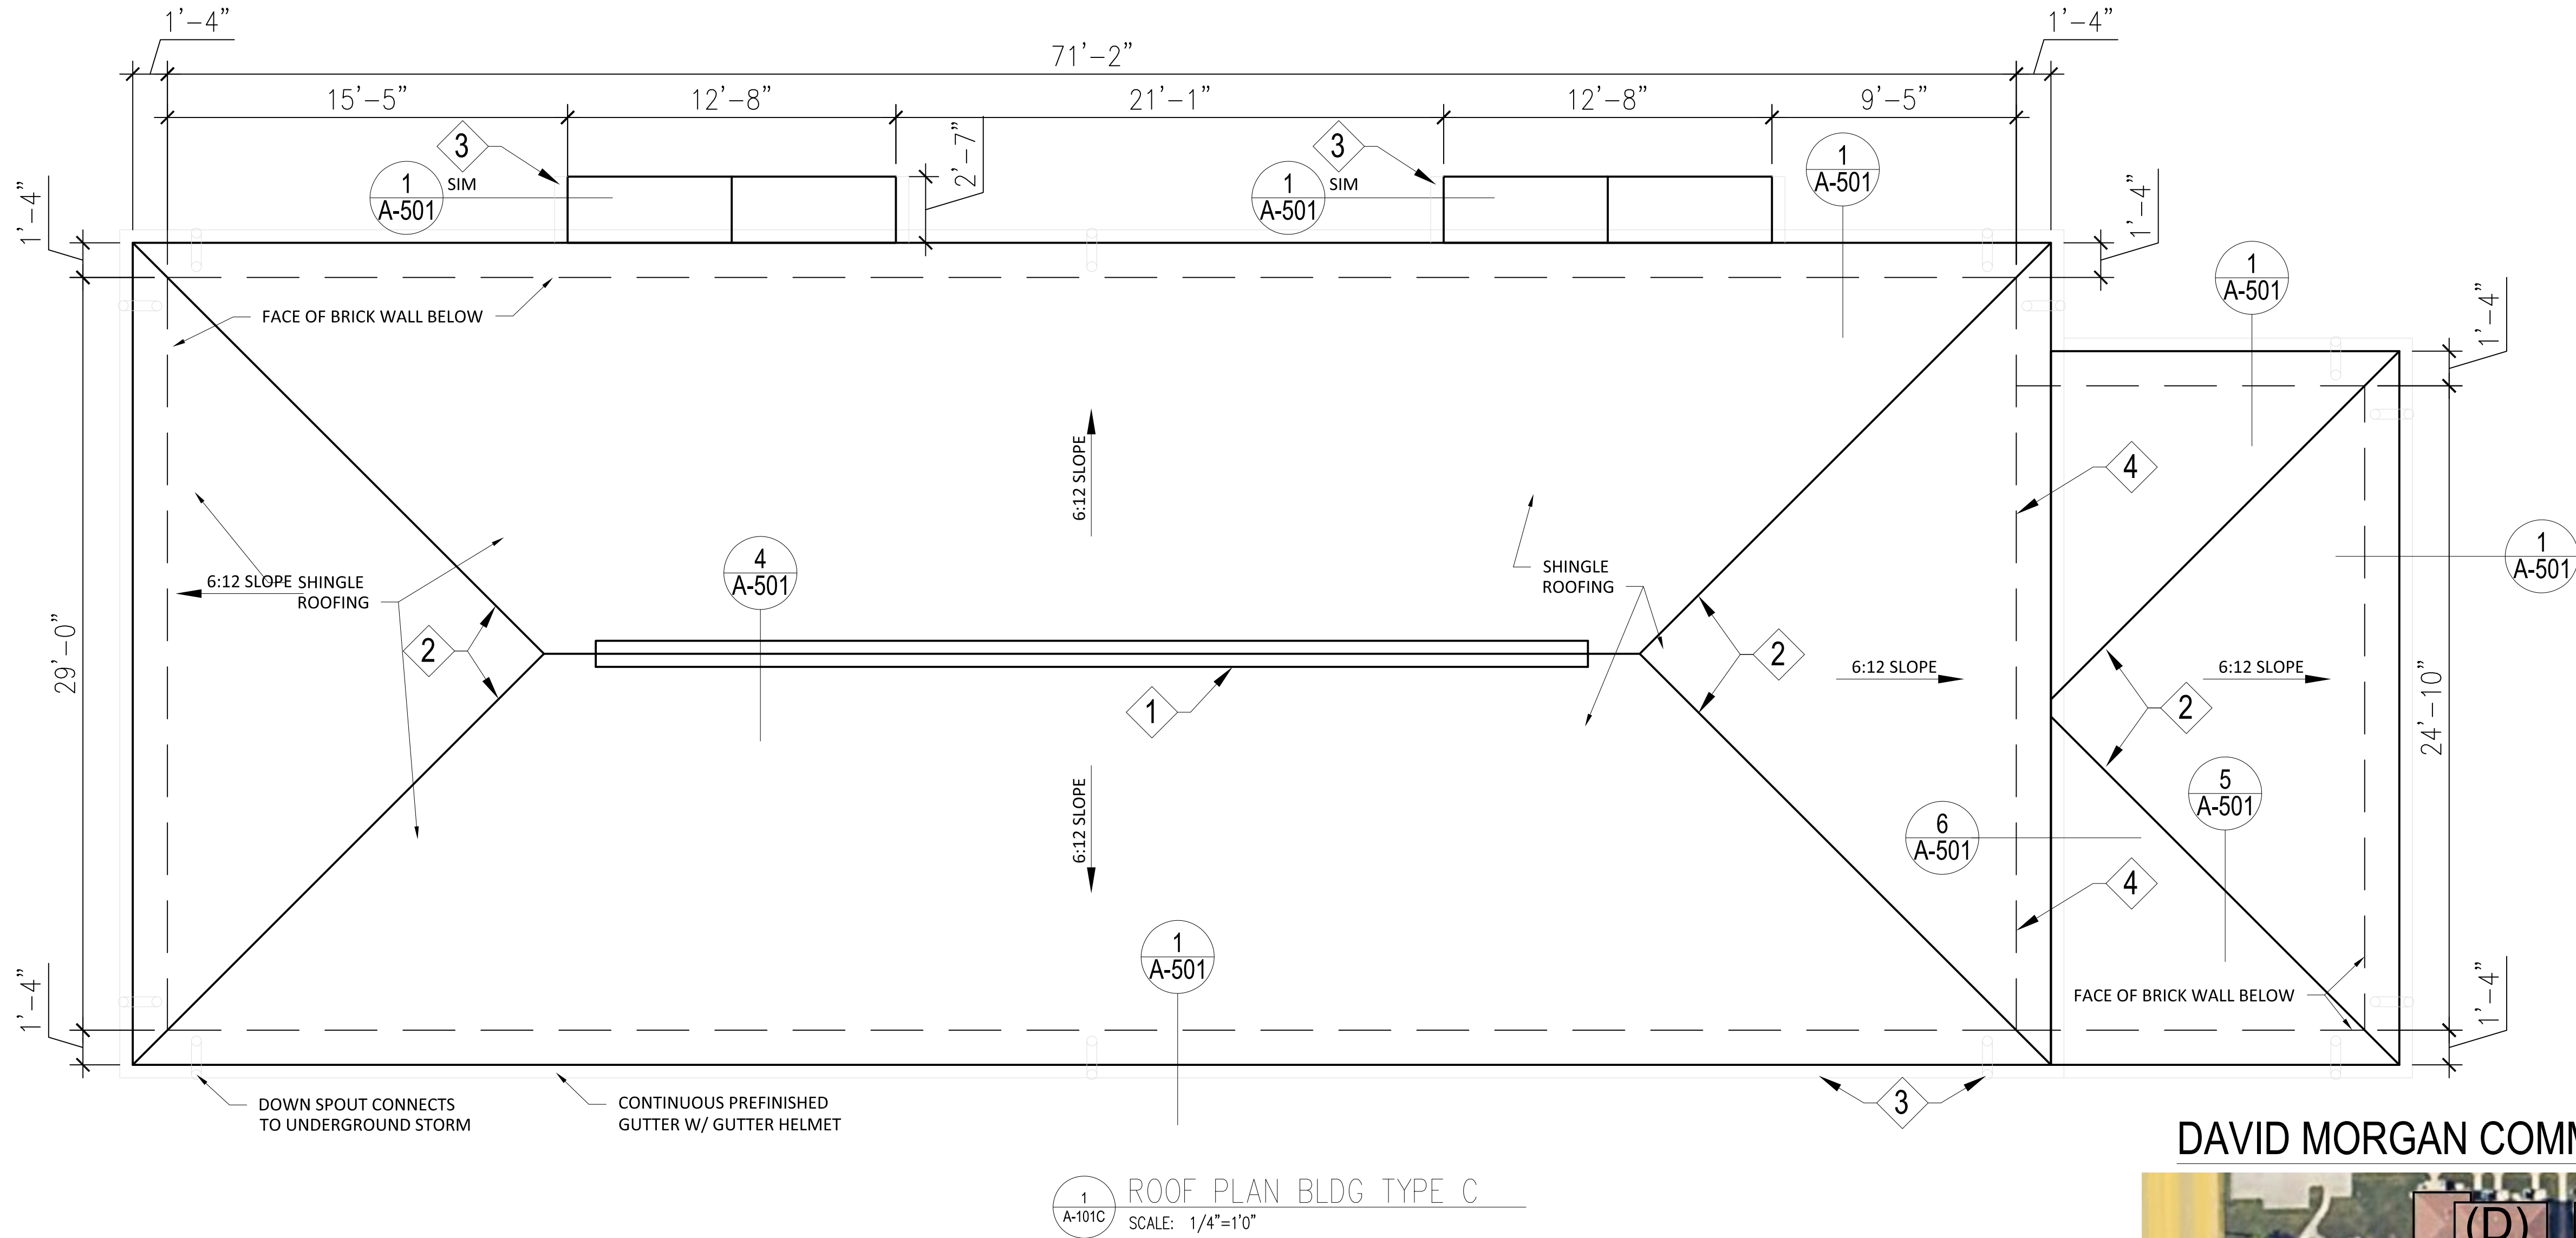
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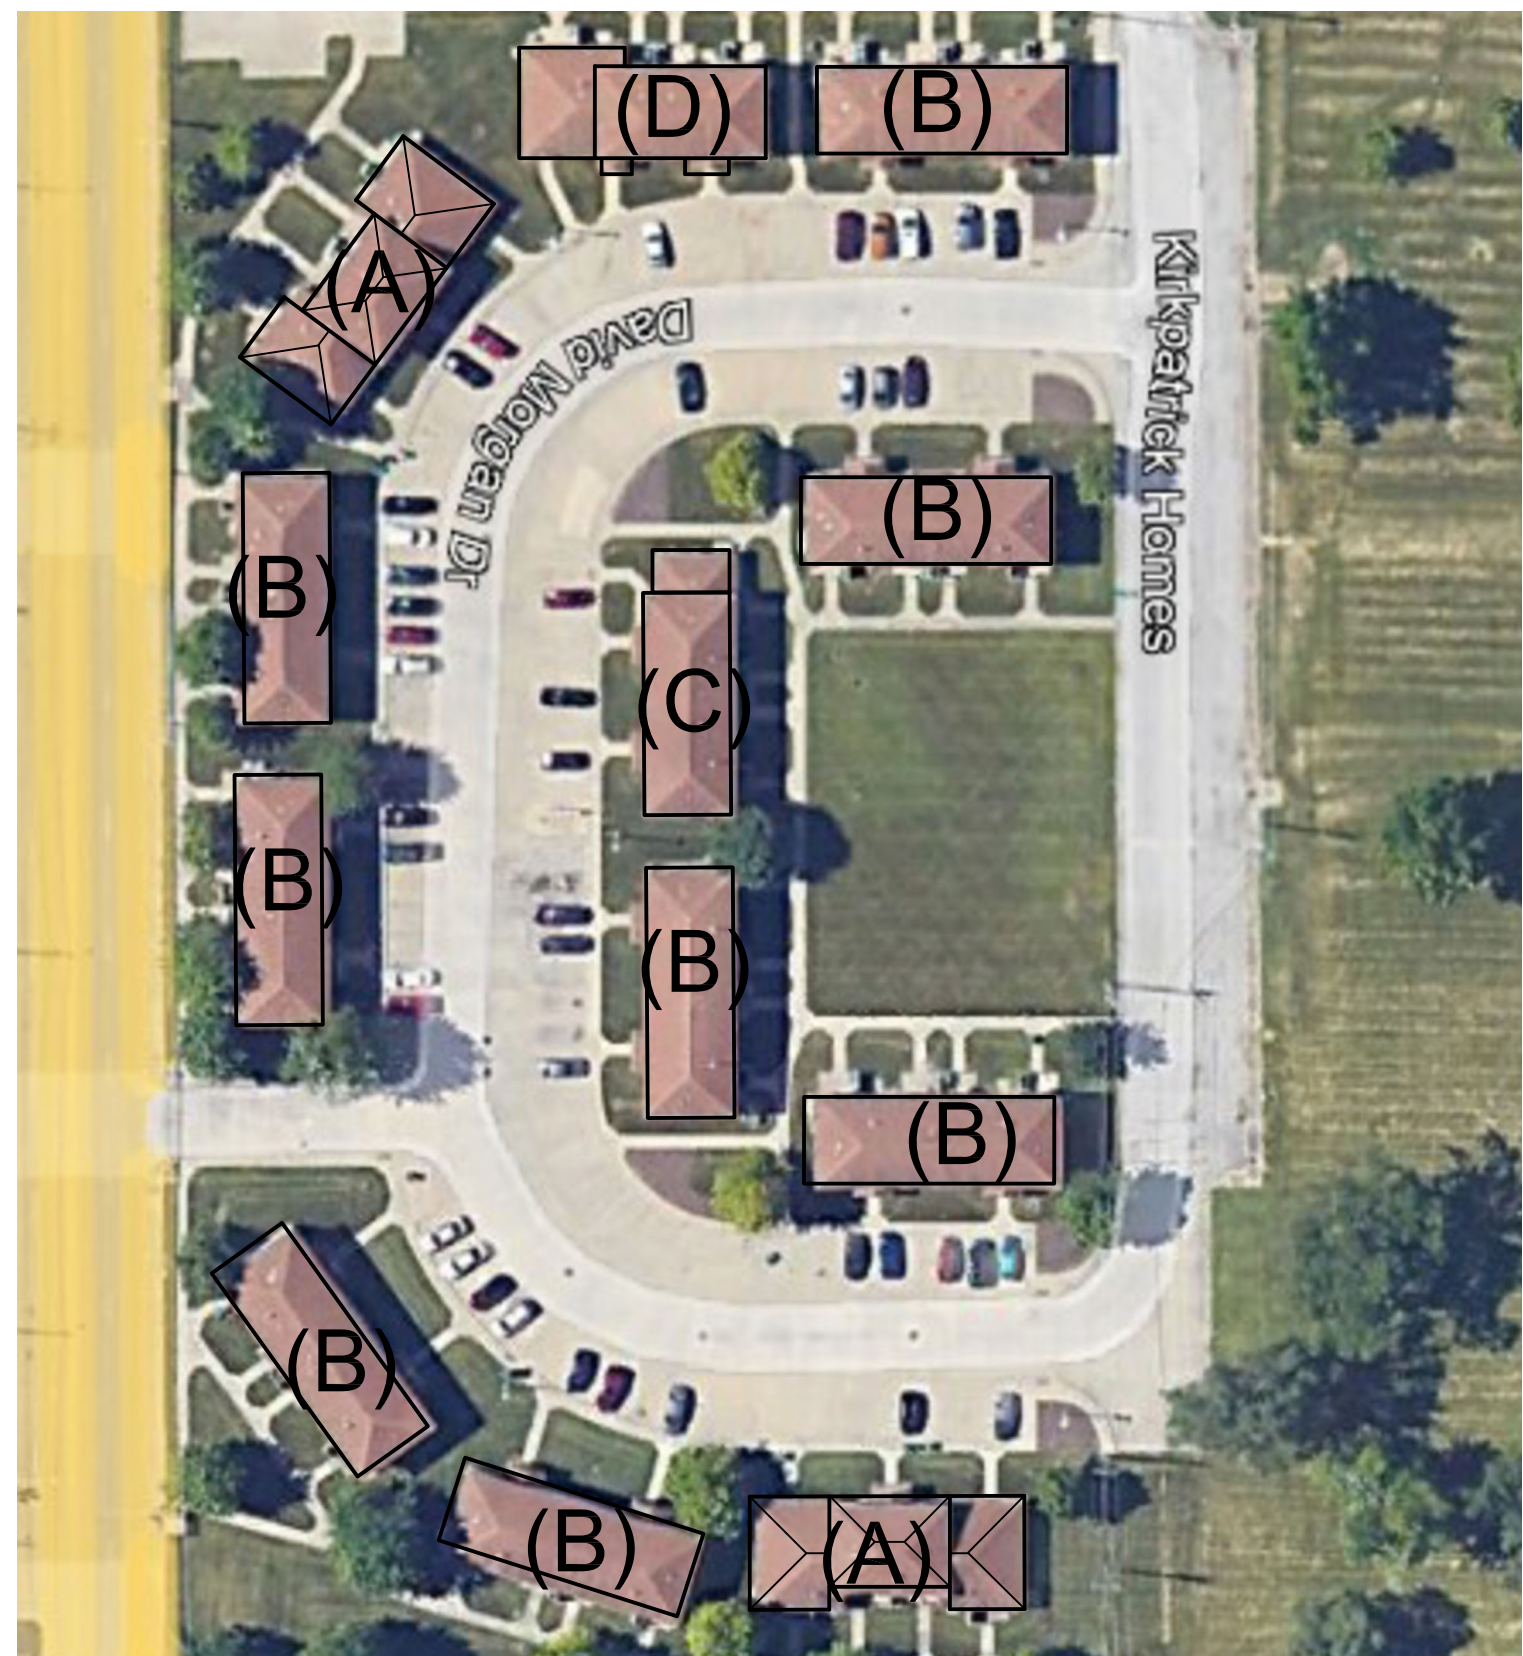
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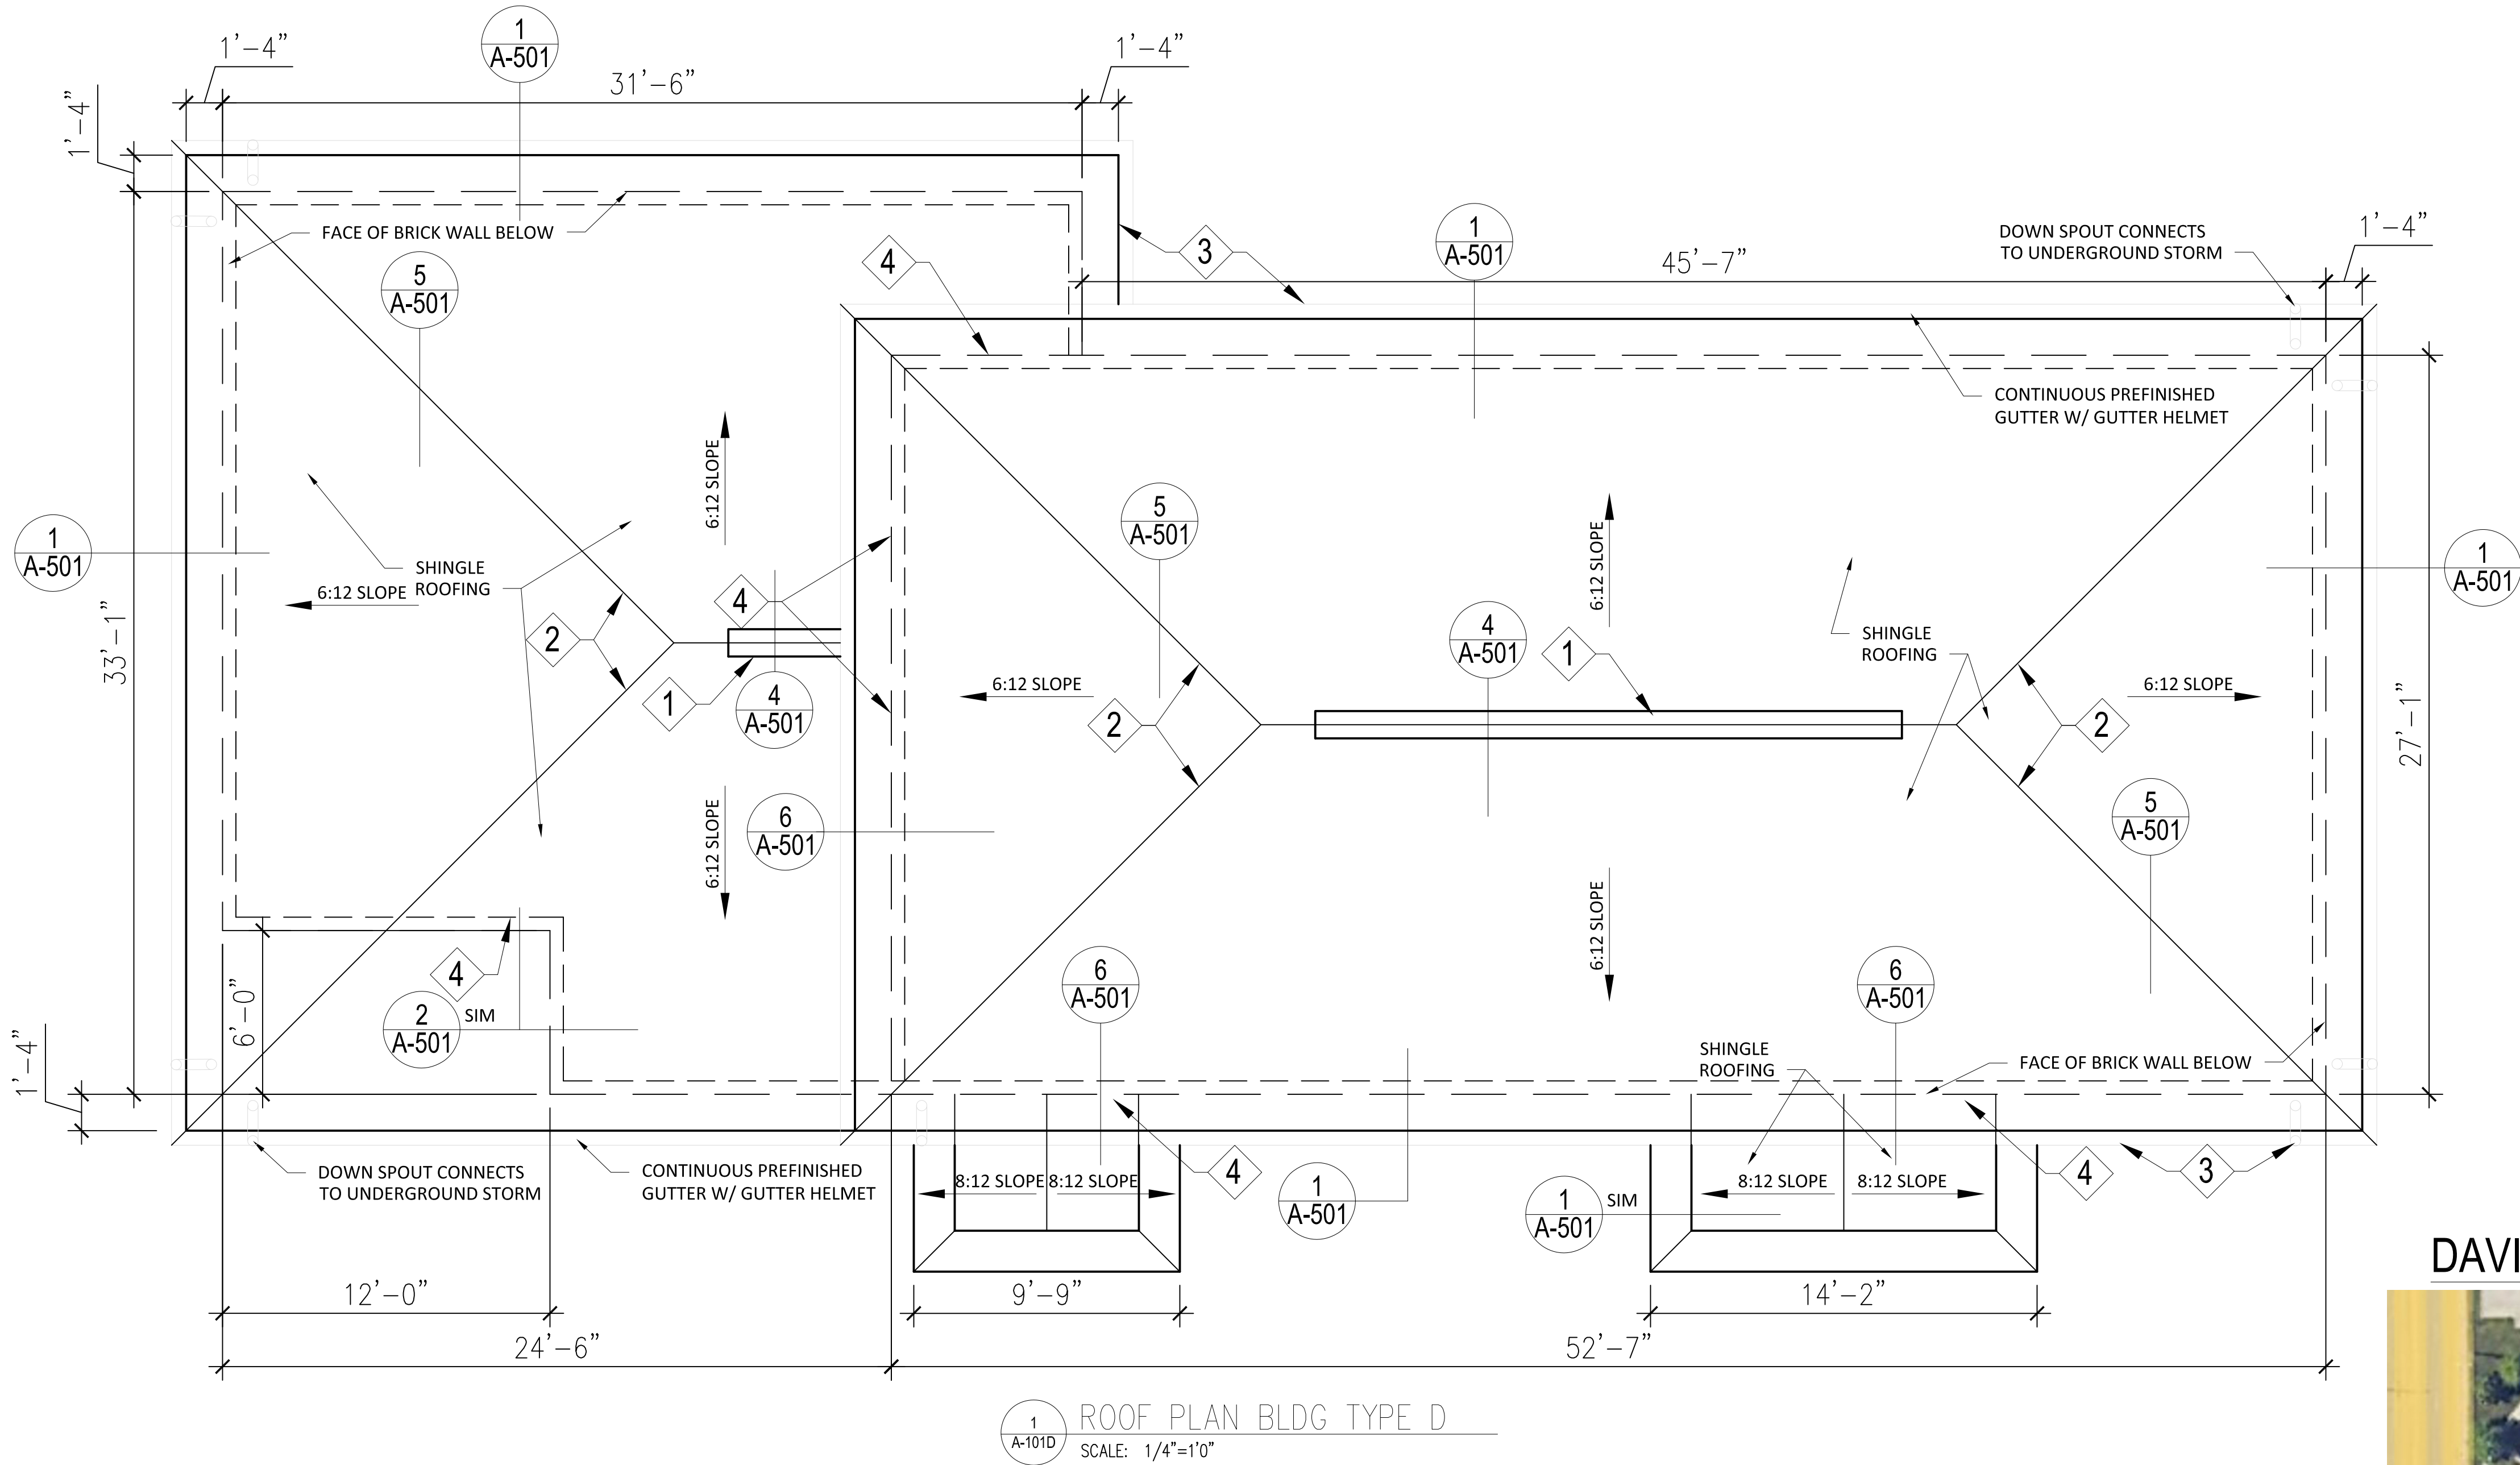
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DATE: 03-11-2024
PROJECT NO: 280-0464
DESIGN: JLW DRAWN: JSM CHECK: JLW

DAVID MORGAN COMMONS
ROOFING PLAN

A-101d

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GENERAL NOTES:

- CONTRACTOR SHALL FIELD VERIFY ALL DIMENSIONS AND CONDITIONS AND MAKE MINOR ADJUSTMENTS AS NECESSARY. NOTIFY ARCHITECT OF ANY DISCREPANCIES WHICH MAY AFFECT THE OUTCOME OF THE WORK.
- ALL EXISTING FINISHES DISTURBED DURING CONSTRUCTION SHALL BE RESTORED TO A CONDITION AT LEAST EQUAL IN MATERIAL AND APPEARANCE TO THAT WHICH EXISTED BEFORE CONSTRUCTION BEGAN.
- THE CONTRACTOR SHALL BE RESPONSIBLE FOR PAYING ALL PERMIT FEES, PAY ITEM AGREEMENTS, TAP FEES, ETC.
- WHETHER SHOWN OR NOT, CONTRACTOR SHALL PROVIDE ALL COMPONENTS REQUIRED TO A COMPLETE INSTALLATION. THIS APPLIES TO ALL TRADES AND DISCIPLINES.
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- PROTECT EXISTING UTILITIES DURING CONSTRUCTION.
- EXISTING SITE AND BUILDING WILL BE OCCUPIED THROUGHOUT CONSTRUCTION. PROVIDE ACCESS TO ALL USERS AND EMERGENCY VEHICLES/PERSONEL AT ALL TIMES. CONTRACTOR TO USE SPECIAL CAUTION IN THE COURSE OF THE WORK, PROTECTION OF THE RESIDENTS AND GUESTS FROM THE WORK, AND CONTINUAL CLEAN-UP WITH NO DEBRIS OR HAZARDS EXPOSED AT THE COMPLETION OF A WORK DAY. THIS APPLIED TO ALL TRADES AND DISCIPLINES.
- CONTRACTOR'S USE OF ANY SCAFFOLDING, LIFTS, SWING STAGES, ETC. SHALL MEET ALL FEDERAL, STATE, AND LOCAL SAFETY REGULATIONS.


GENERAL ROOFING NOTES:

- REMOVE ALL EXISTING ASPHALT ROOF SHINGLES AND FELT UNDERLAYMENT TO THE EXISTING ROOF SHEATHING. EXISTING PERIMETER ICE AND WATER DAM MEMBRANE SHALL REMAIN IN PLACE WHERE EXISTING.
- CONTRACTOR SHALL REMOVE AND PROPERLY DISPOSE OF ALL EXISTING PERIMETER SHEET METAL DRIP EDGE FLASHING, GUTTERS AND DOWNSPOUTS. INSTALL NEW PREFINISHED ALUMINUM DRIP EDGE, GUTTERS AND DOWNSPOUTS TO MATCH EXISTING. SEE TYPICAL DETAILS ON SHEET A-501.
- INSTALL NEW ARCHITECTURAL SHINGLES OVER SYNTHETIC UNDERLAYMENT AND NEW ICE DAM AT ROOF PERIMETER AND VALLEYS. CONTRACTOR SHALL REMOVE ALL EXISTING AND INSTALL NEW ROOF PENETRATION FLASHINGS AND ALUMINUM VENT CAPS. FIELD VERIFY SIZE, QUANTITY, AND LOCATION. SEE TYPICAL ROOFING DETAILS ON SHEET A-501.
- CONTRACTOR SHALL TAKE NOTE OF ALL EXISTING BUILDING MOUNTED EQUIPMENT, UTILITIES, WIRING, FIXTURES, DEVICES AND ACCESSORIES INCLUDING BUT NOT LIMITED TO ALL, PHONE AND CABLE WIRES, SATELLITE DISHES, AIR CONDITIONING DISCONNECTS, AND ASSOCIATED WIRING AND ACCESSORIES, ETC. AND REMOVE AND REINSTALL AS REQUIRED TO COMPLETE ALL WORK.

KEYED NOTES:

- REMOVE EXISTING AND INSTALL NEW SHINGLE-OVER RIDGE VENT. SEE TYP. DETAIL ON SHT. A-501.
- REMOVE EXISTING AND INSTALL NEW VALLEY/TRANSITION FLASHING. SEE TYP. DETAIL ON SHT. A-501.
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- WALL FLASHING PER TYP. DETAIL ON SHT. A-501.

DAVID MORGAN COMMONS BLDG. TYPES

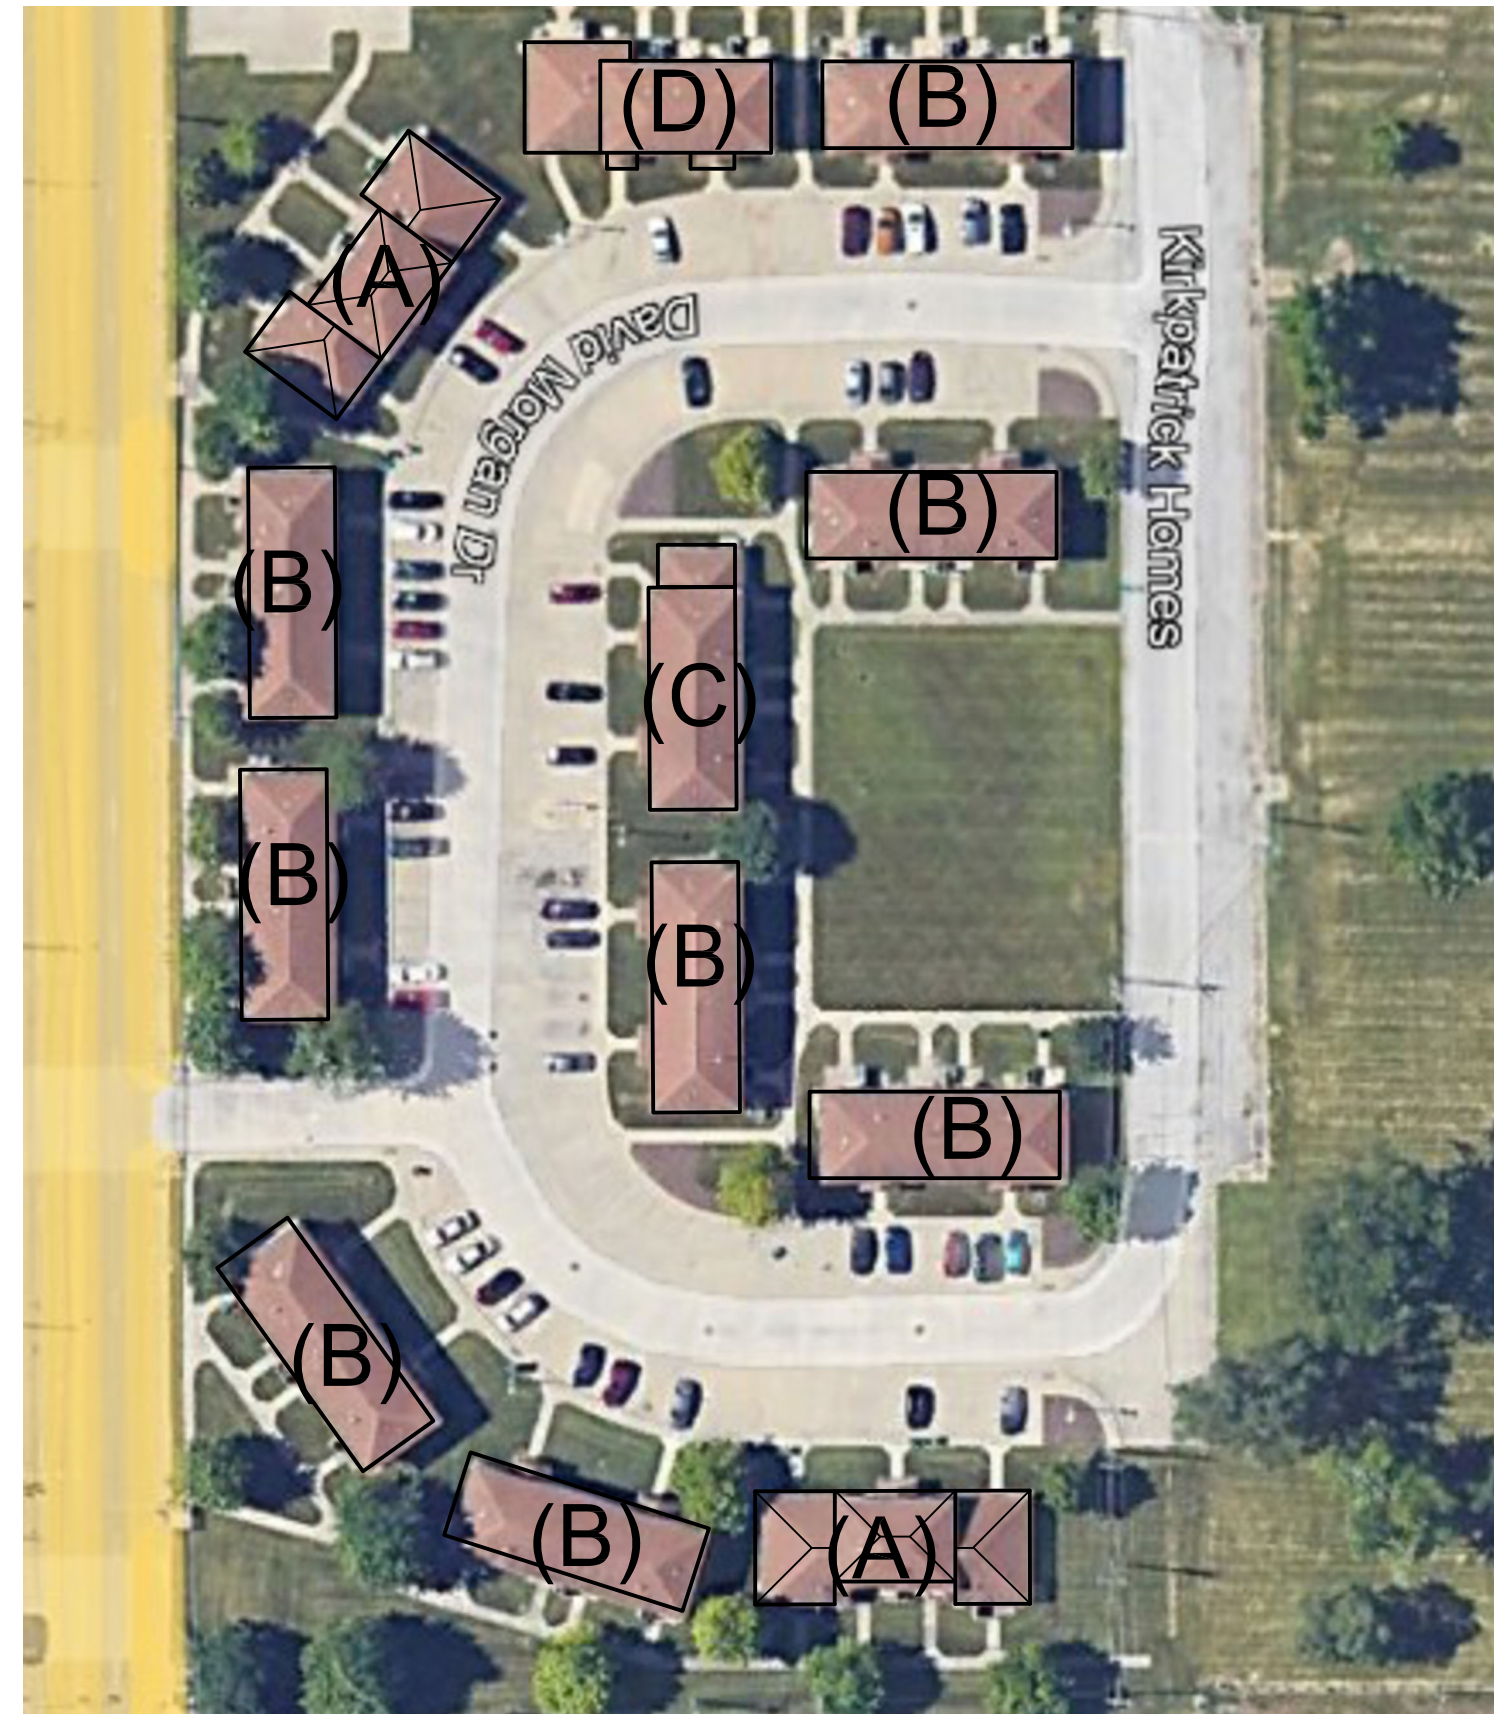

(A) = 4 UNITS: 2 bldgs. (B) = 4 UNITS: 8 bldgs.
(C) = 4 UNITS: 1 bldg. (D) = 4 UNITS: 1 bldg.

SIGNATURE
xx-xx-2024

DATE
11-30-2024

LICENSE EXPIRES

BP3, ROOF REPLACEMENTS, MULTIPLE SITES:

DAVID MORGAN COMMONS
ANCHORAGE HOMES
OAK TREE VILLAS
GRANITE CITY HOUSING AUTHORITY
GRANITE CITY, ILLINOIS 62040

MK.	DATE	DESCRIPTION


DATE: 03-11-2024

PROJECT NO: 280-0464

DESIGN: JLW DRAWN: JSM CHECK: JLW

ANCHORAGE HOMES
4-UNIT ROOFING PLAN

A-102a

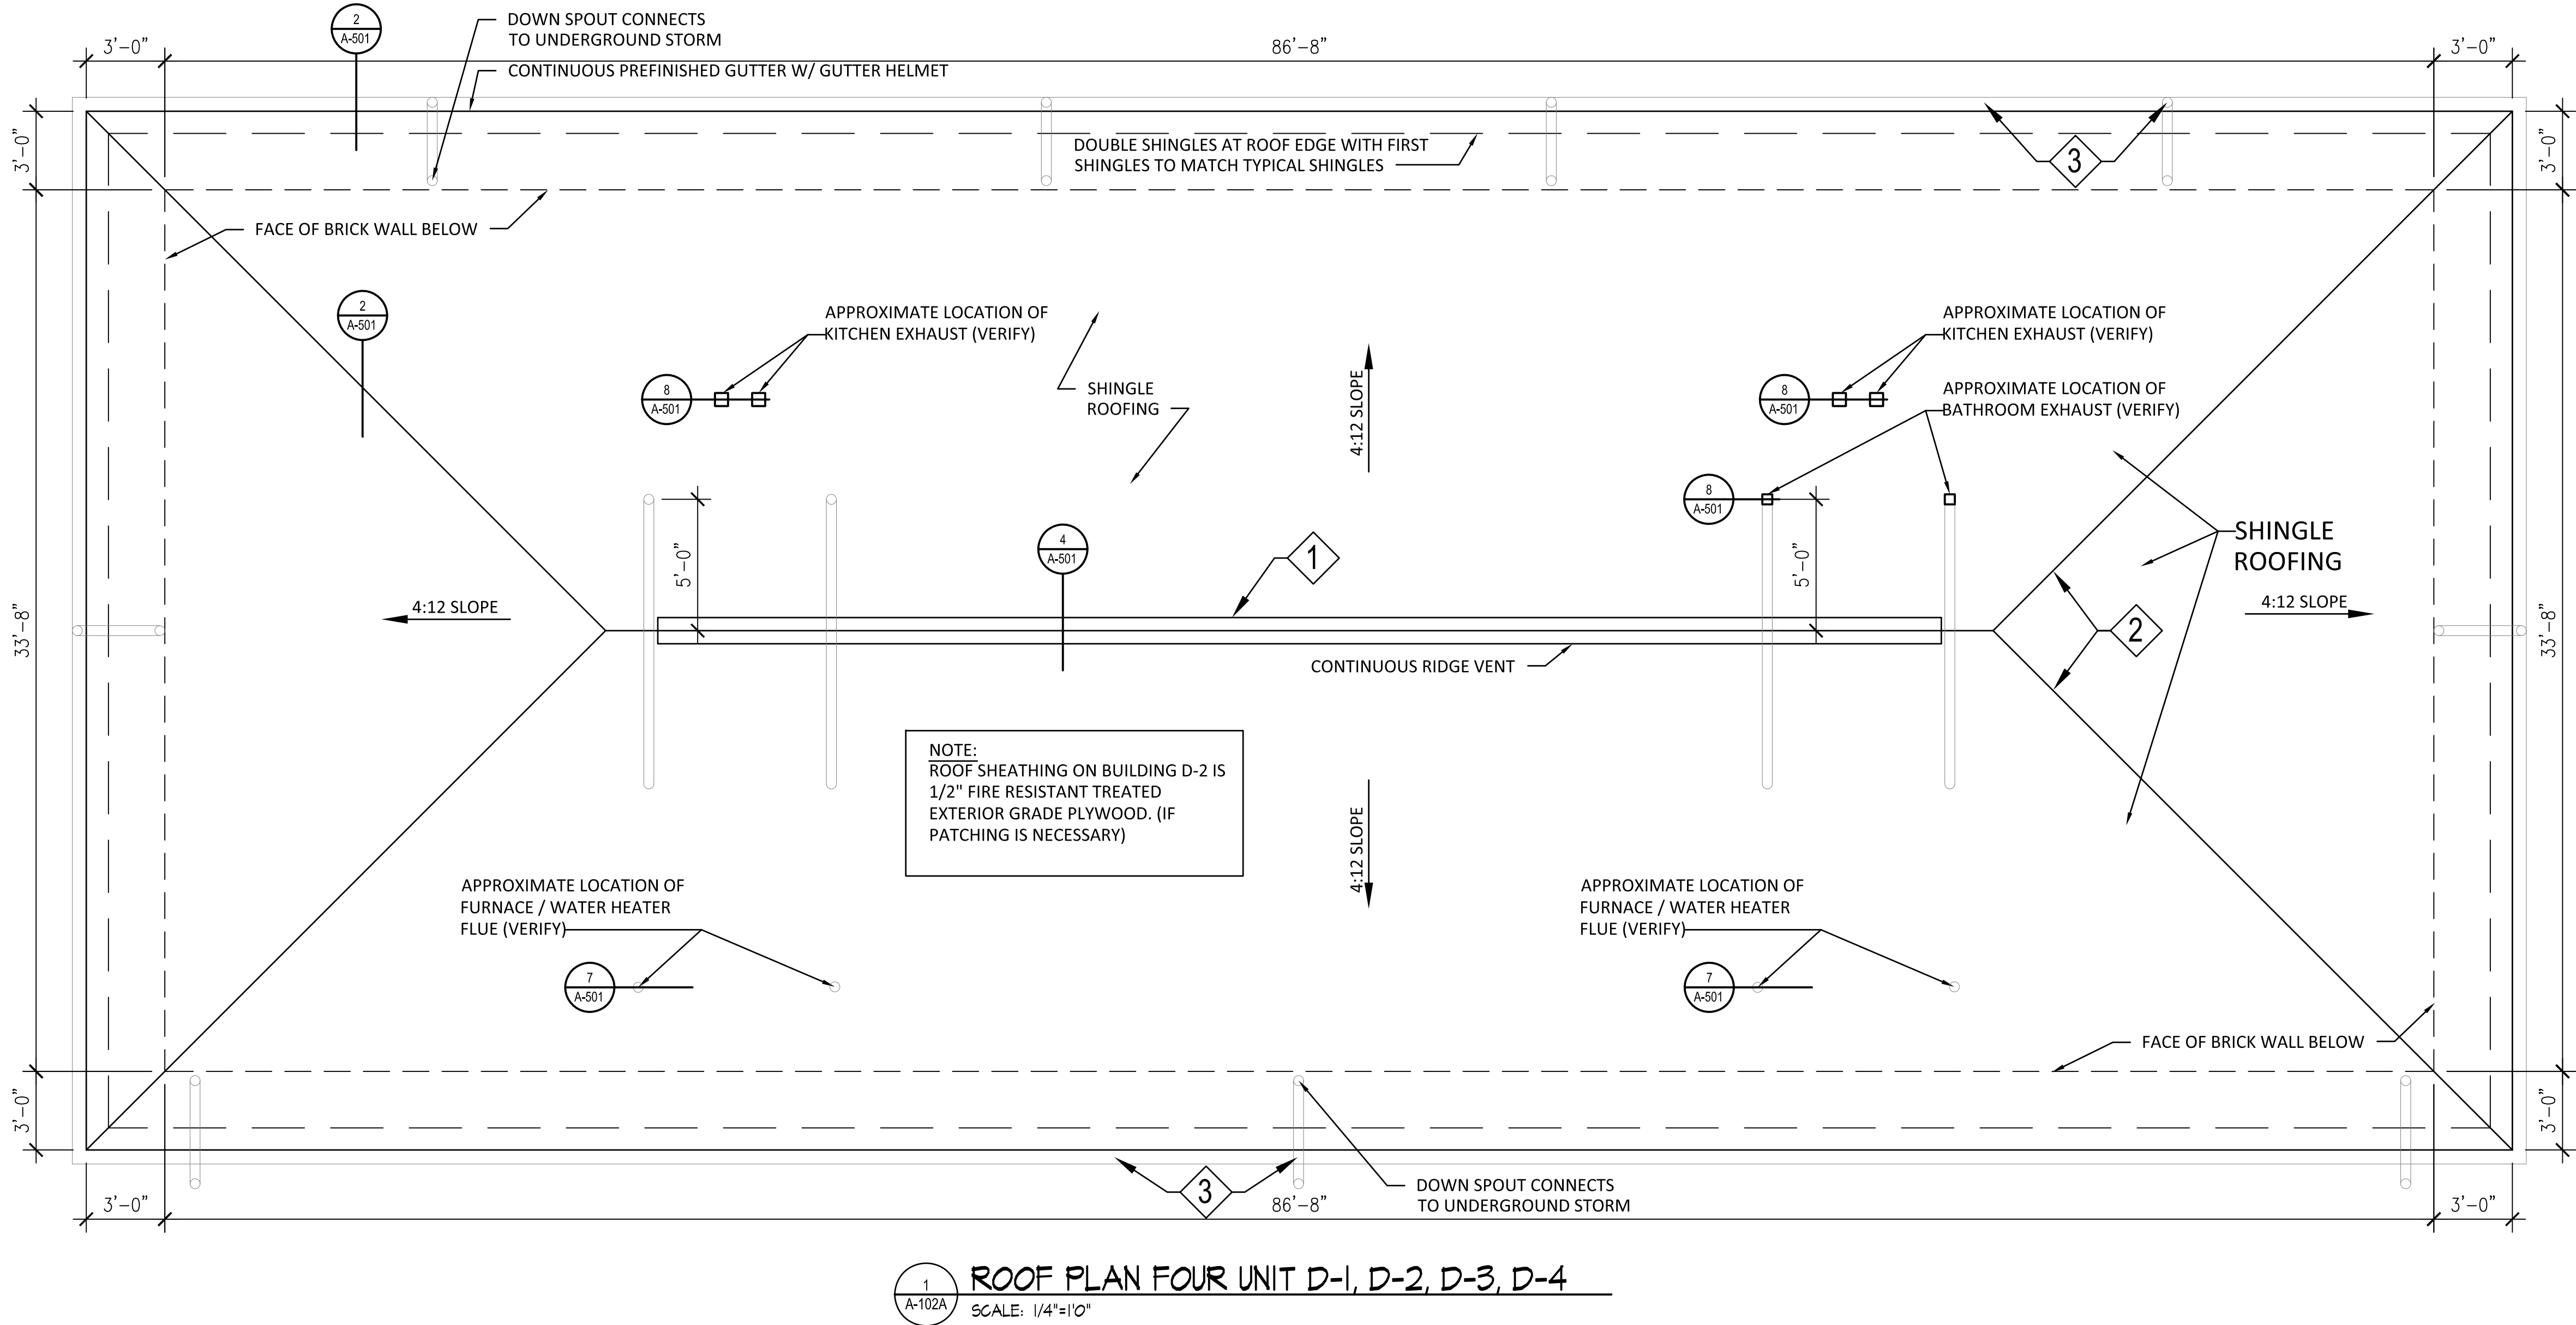

GENERAL NOTES:

- CONTRACTOR SHALL FIELD VERIFY ALL DIMENSIONS AND CONDITIONS AND MAKE MINOR ADJUSTMENTS AS NECESSARY. NOTIFY ARCHITECT OF ANY DISCREPANCIES WHICH MAY AFFECT THE OUTCOME OF THE WORK.
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GENERAL ROOFING NOTES:

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- WALL FLASHING PER TYP. DETAIL ON SHT. A-501.

ANCHORAGE HOMES BLDG. TYPES



(4) = 4 UNITS: 4 bldgs. (6) = 6 UNITS: 4 bldgs.



Hurst-Rosche, Inc.
PROFESSIONAL DESIGN NUMBER: 184-00208

NO. 5 BANK SQUARE
EAST ST. LOUIS, IL.
PH: 618.398.0890

www.hurst-rosche.com

HILLSBORO, IL
SPRINGFIELD, IL
MARION, IL
NASHVILLE, TN
ARNOLD, MO

SIGNATURE
xx-xx-2024
DATE 11-30-2024
LICENSE EXPIRES

BP3, ROOF REPLACEMENTS, MULTIPLE SITES:

DAVID MORGAN COMMONS
ANCHORAGE HOMES
OAK TREE VILLAS
GRANITE CITY HOUSING AUTHORITY
GRANITE CITY, ILLINOIS 62040


MK.	DATE	DESCRIPTION

DATE: 03-11-2024
PROJECT NO: 280-0464
DESIGN: JLV DRAWN: JSM CHECK: JLV

ANCHORAGE HOMES
6-UNIT ROOFING PLAN

A-102b

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1 ROOF PLAN SIX UNIT C-1, C-2, C-3, C-4
A-102B SCALE: 3/16"=1'0"
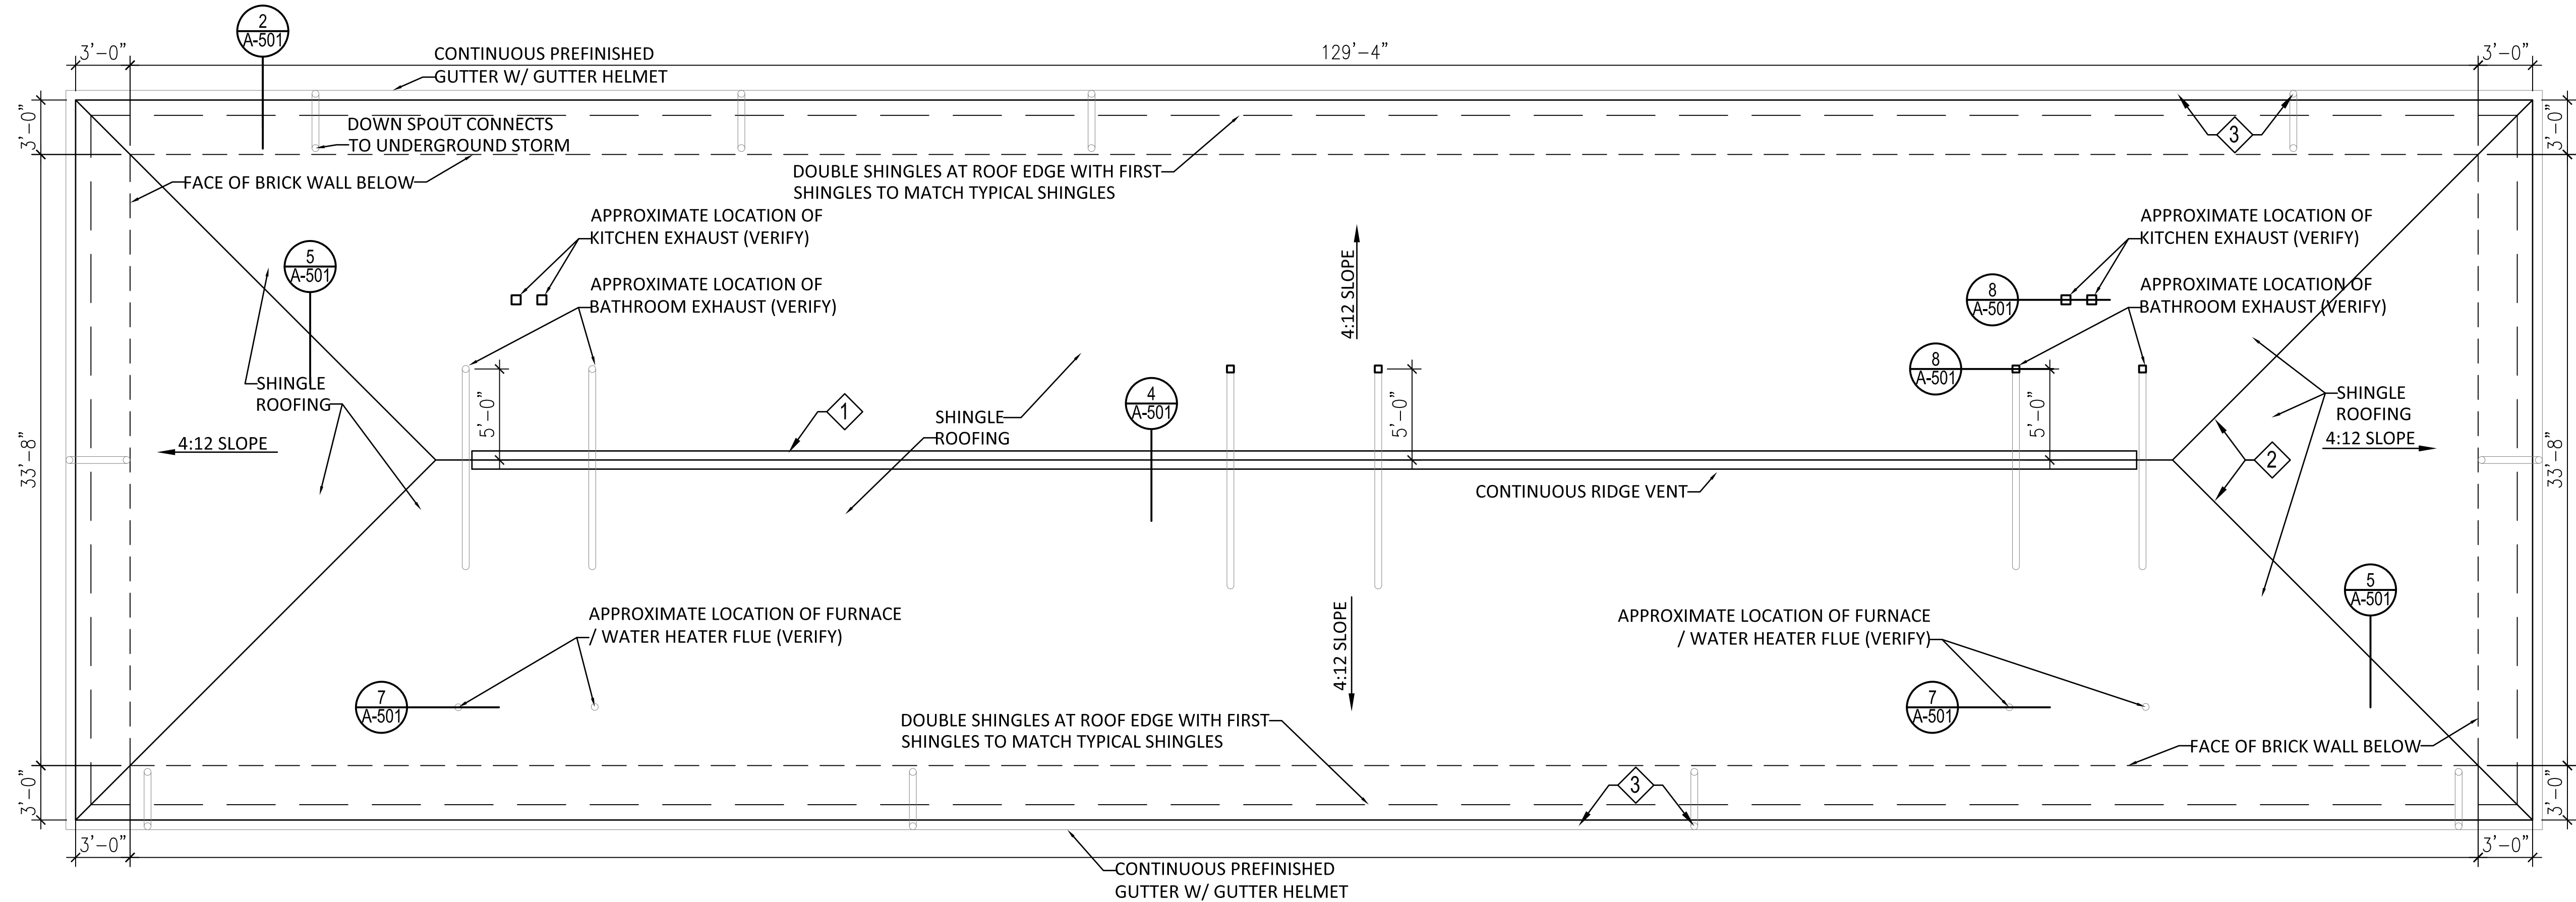
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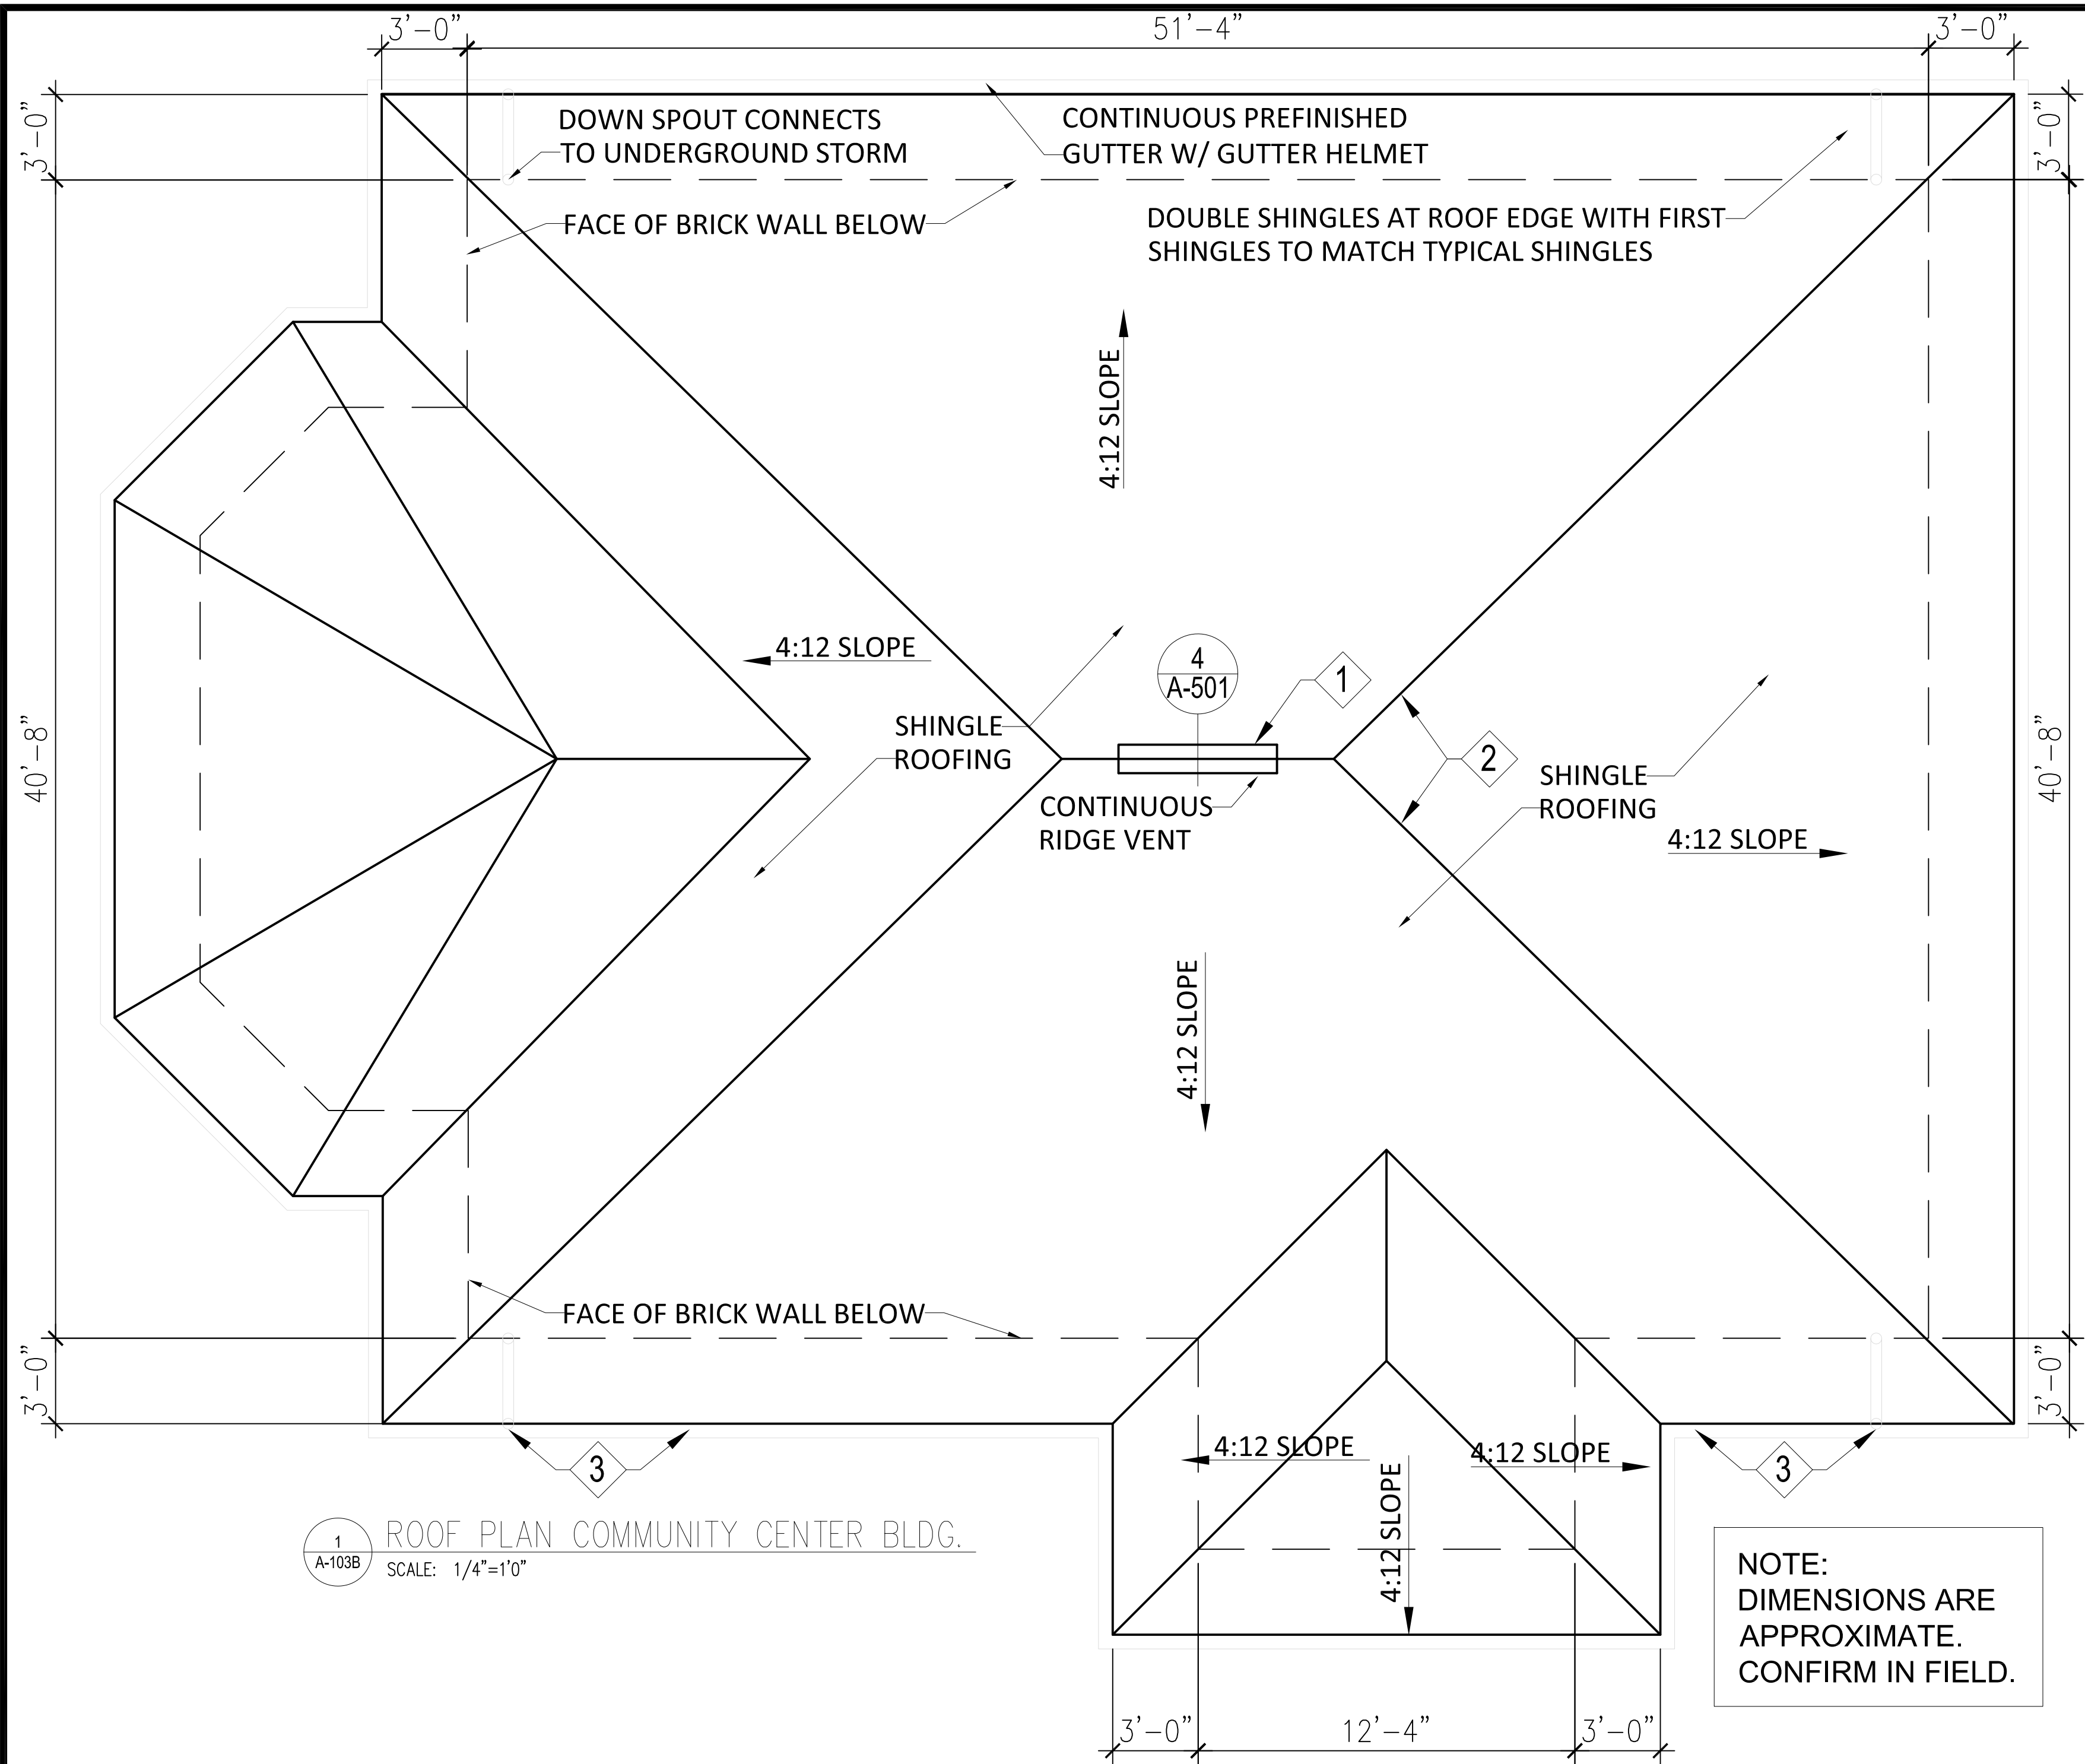
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ANCHORAGE HOMES BLDG. TYPES



(4) = 4 UNITS: 4 bldgs. (6) = 6 UNITS: 4 bldgs.



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(4) = 4 UNITS: 12 bldgs. (CC) = COMMUNITY CENTER

HR

Hurst-Rosche, Inc.

PROFESSIONAL DESIGN NUMBER: 184-000298

NO. 5 BANK SQUARE
EAST ST. LOUIS, IL.
PH: 618.398.0890

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HILLSBORO, IL
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LICENSE EXPIRES	

BP3, ROOF REPLACEMENTS, MULTIPLE SITES:


DAVID MORGAN COMMONS
ANCHORAGE HOMES
OAK TREE VILLAS
GRANITE CITY HOUSING AUTHORITY
GRANITE CITY, ILLINOIS 62040

MK.	DATE	DESCRIPTION


DATE: 03-11-2024
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OAK TREE VILLAS
ROOFING PLANS

A-103b

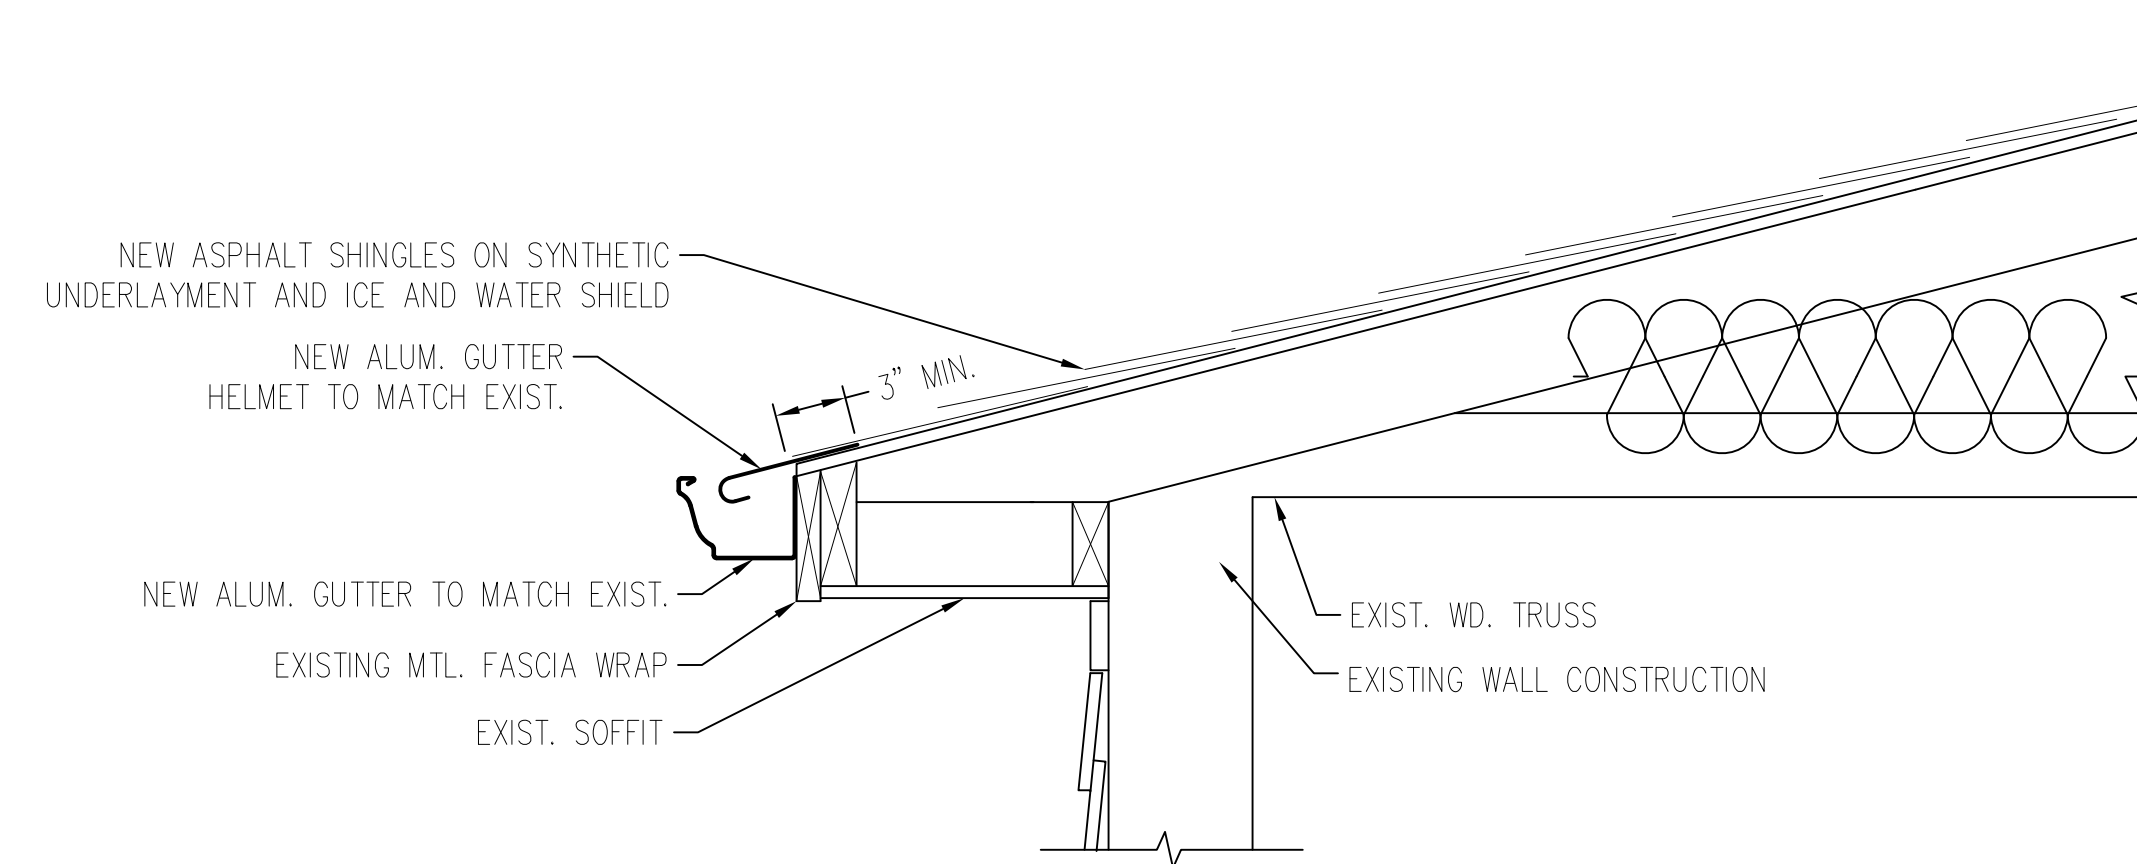


1 SHINGLE TYPE ROOF DETAIL
A-501 SCALE: N.T.S.

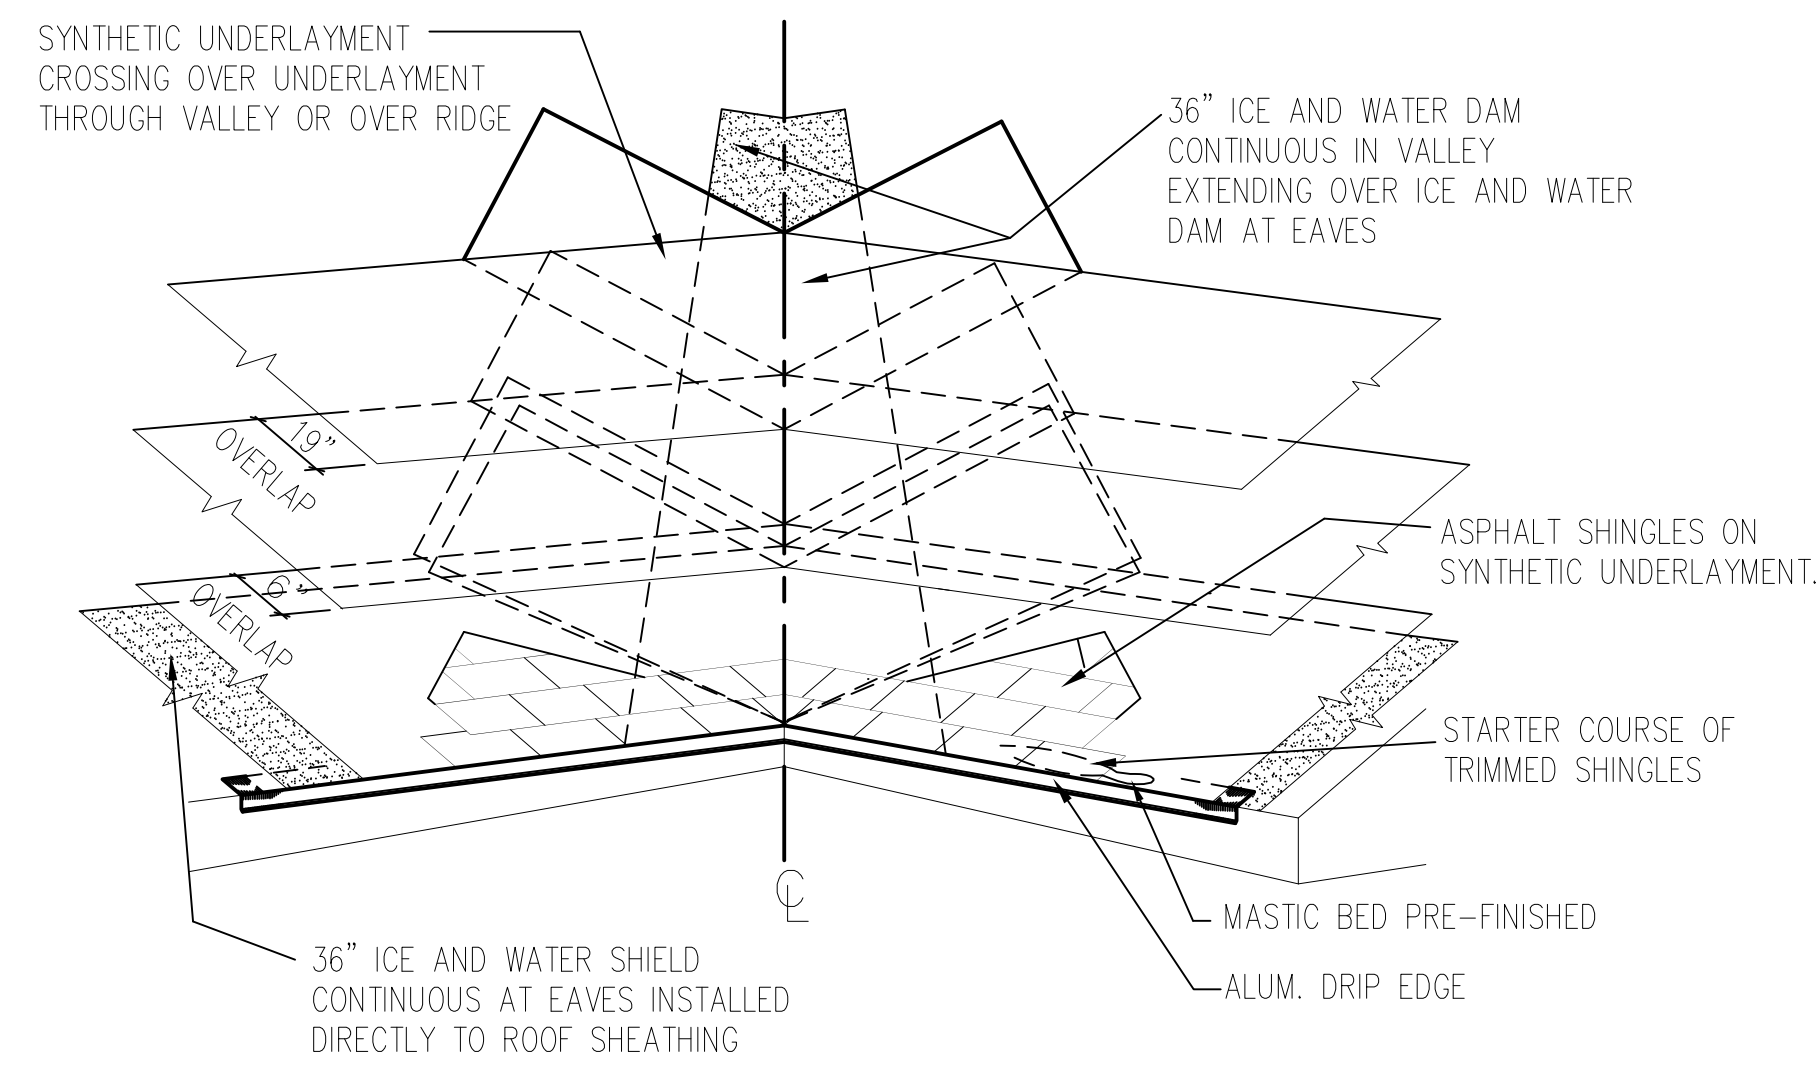


5
A-501


TYP. ROOF VALLEY / HIP DETAIL
SCALE: N.T.S.

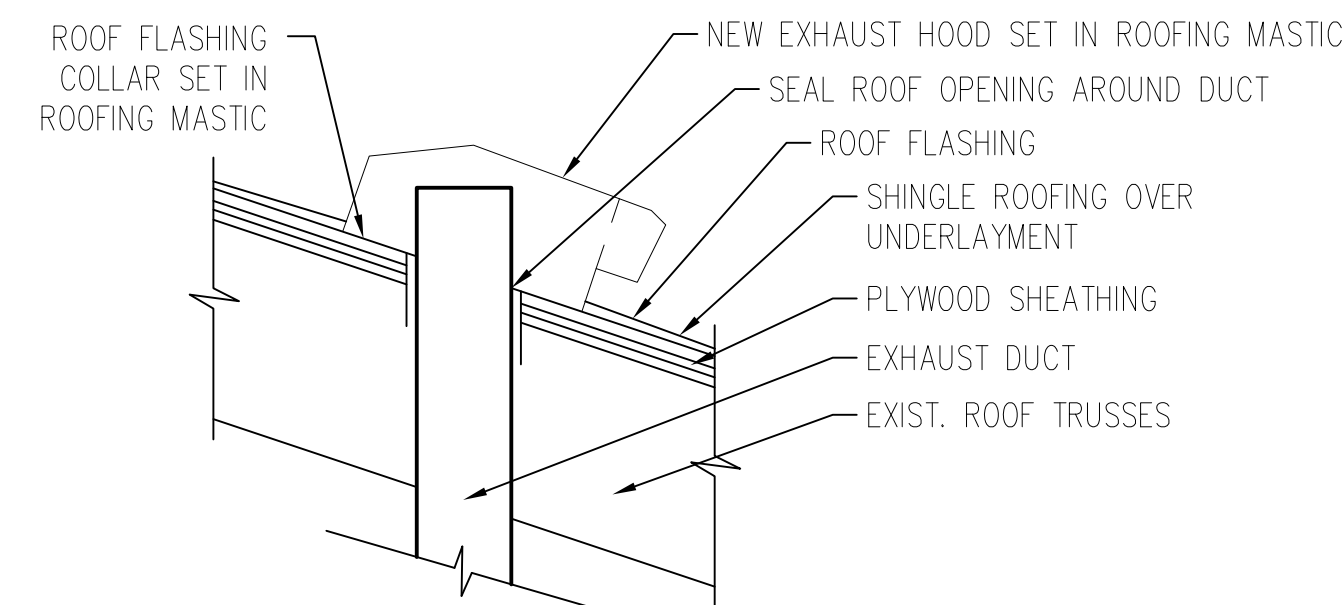

8 TYP. ROOF EXHAUST DETAIL
A-501 SCALE: N.T.S.

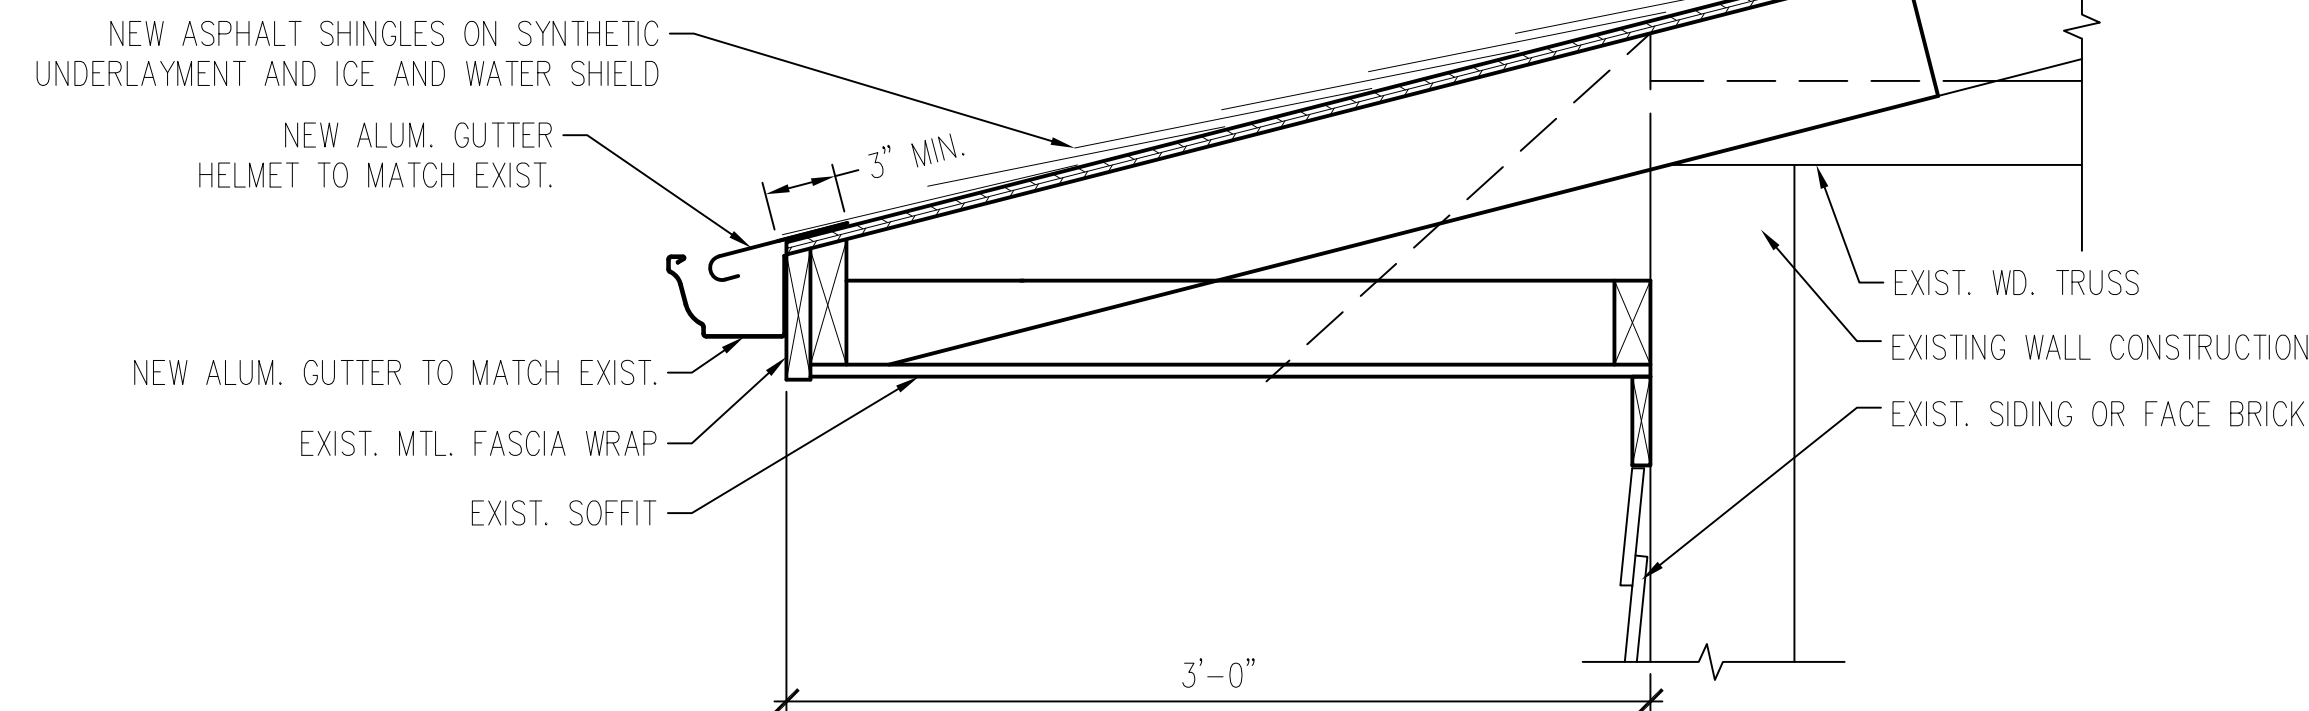


2 SHINGLE TYPE ROOF DETAIL
A-501 SCALE: N.T.S.

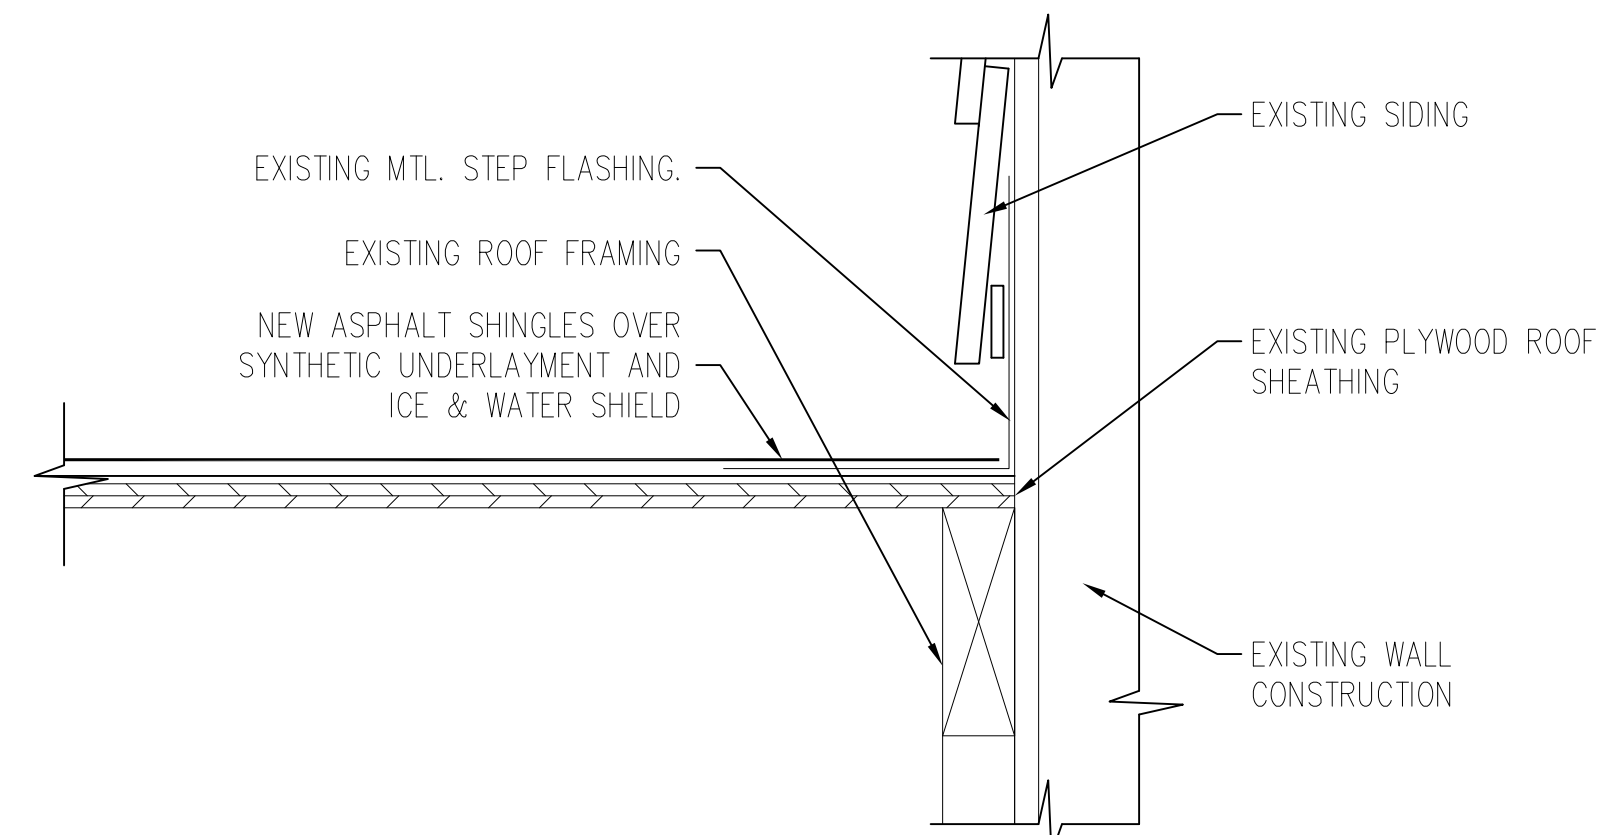

6
A-501


TYP. ROOF AT WALL TERMINATION DETAIL

SCALE: N.T.S.

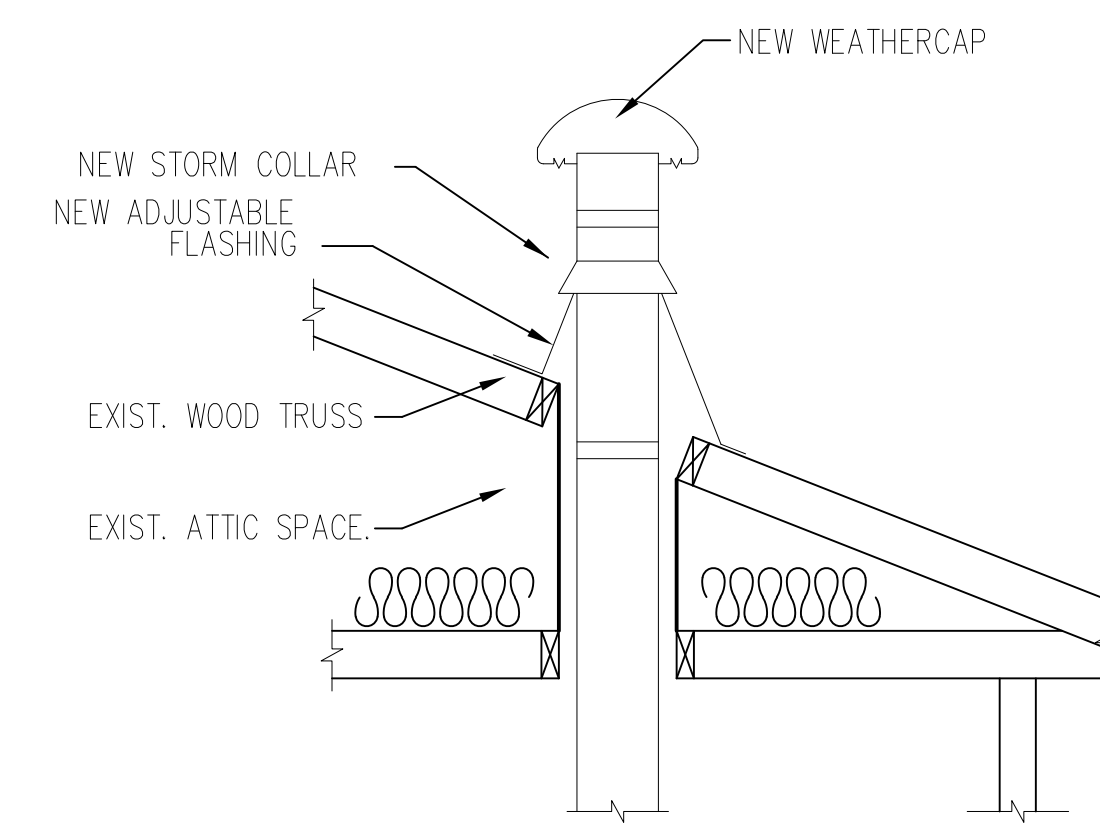


7
A-501

TYP. ROOF FLUE VENT DETAIL
SCALE: N.T.S.

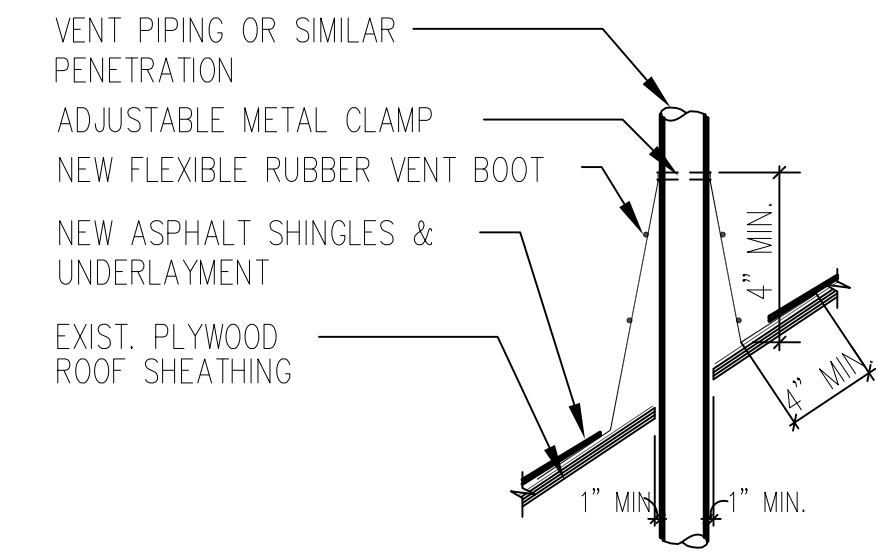

3 SHINGLE TYPE ROOF DETAIL
A-501 SCALE: N.T.S.

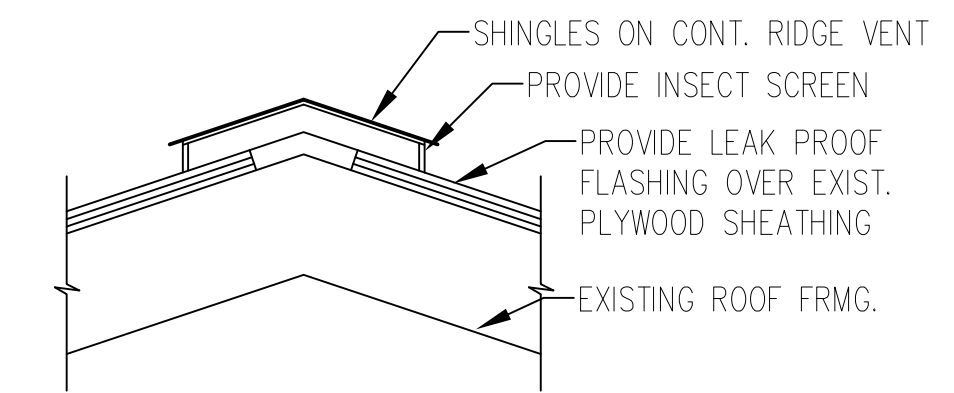

4 TYP. RIDGE VENT DETAIL
A-501 SCALE: N.T.S.

SIGNATURE _____

xx-xx-2024

DATE 11.30.2024

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GRANITE CITY HOUSING AUTHORITY

GRANITE CITY, ILLINOIS 62040

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MISC. ROOFING DETAILS